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Tel: 1-800-363-7512 www.ontarionorthland.ca

June 19, 2024

Addendum No. 01

File Reference Number: RFP 2024 026

Title: AODA Compliance for Cochrane and Englehart

**RE: Clarifications/Questions** 

Please refer to the following information / clarifications:

## **QUESTIONS**

**Item 1:** Please provide as-built drawings associated with these buildings including architectural, mechanical and electrical.

**Answer:** Please find below the list of drawings –

Cochrane Building – The following list of drawings are attached at Appendix A at the end of this Addendum.

List of Drawings
20170310121221232
A-1 Lower Level Floor Plan and Foundation Plan
A-3 Elevations
A-4 Building Sections and Details
A-5 Building Sections and Details
A-6 Sections and Details
A-9 Lower Level Demolition Plan

Englehart Building – The following list of drawings are attached at Appendix B at the end of this Addendum.

A-2 Basement Plan Reflected Ceiling Plan & Plan Details
A-3 Ground Floor Plan Reflected Ceiling Plan & Plan Details
A-4 Second Floor Plan Reflected Ceiling Plan & Plan Details
A-6 Building Section – Stair Sections and Details
A-7 Wall Sections and Section Details
M-3 Basement and Ground Floor Ventilation & Air Conditioning Plans
M-3 Basement and Ground Floor Ventilation & Air Conditioning Plans
M-4 Second Floor Ventilation & Air Conditioning Plan & Details


This Addendum hereby forms part of the RFP.


All other terms and conditions of the RFP remain the same and are unchanged.

Regards,

Brinda Ranpura Procurement Contracts Specialist <u>brinda.ranpura@ontarionorthland.ca</u>




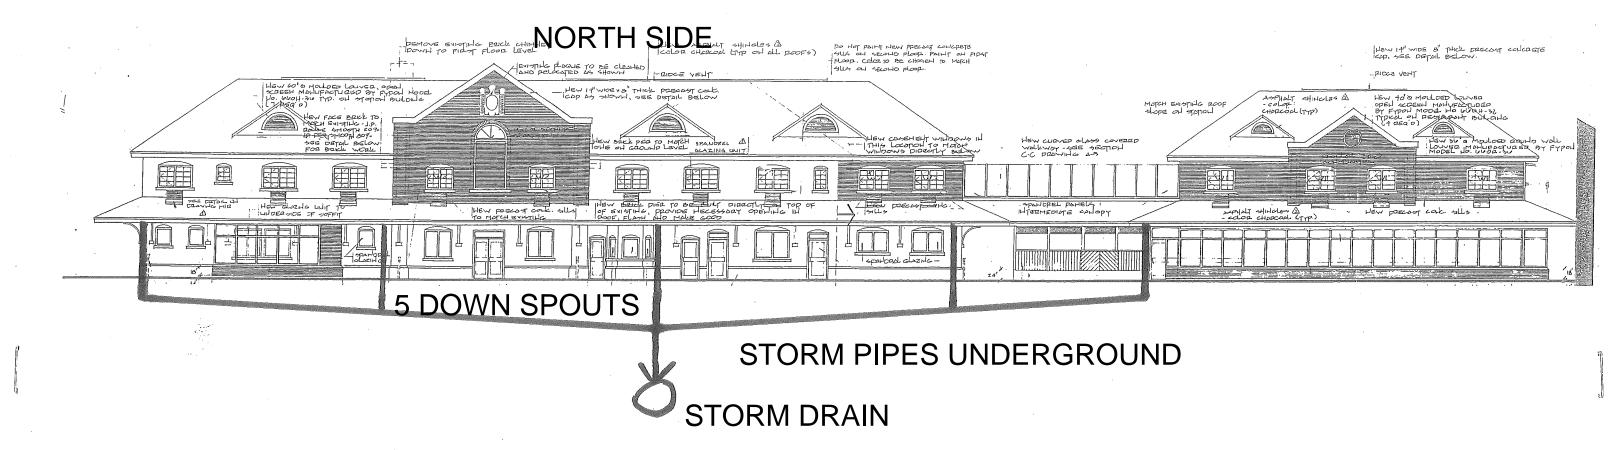


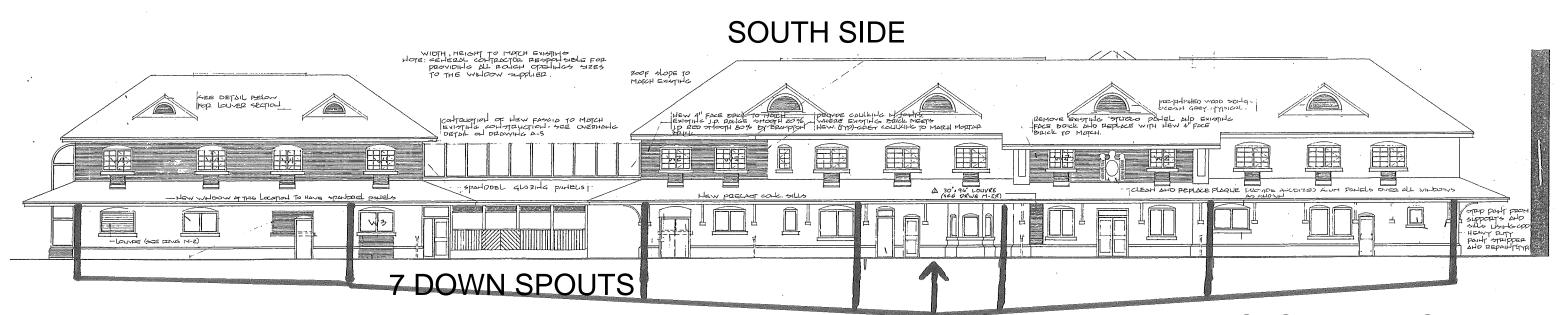



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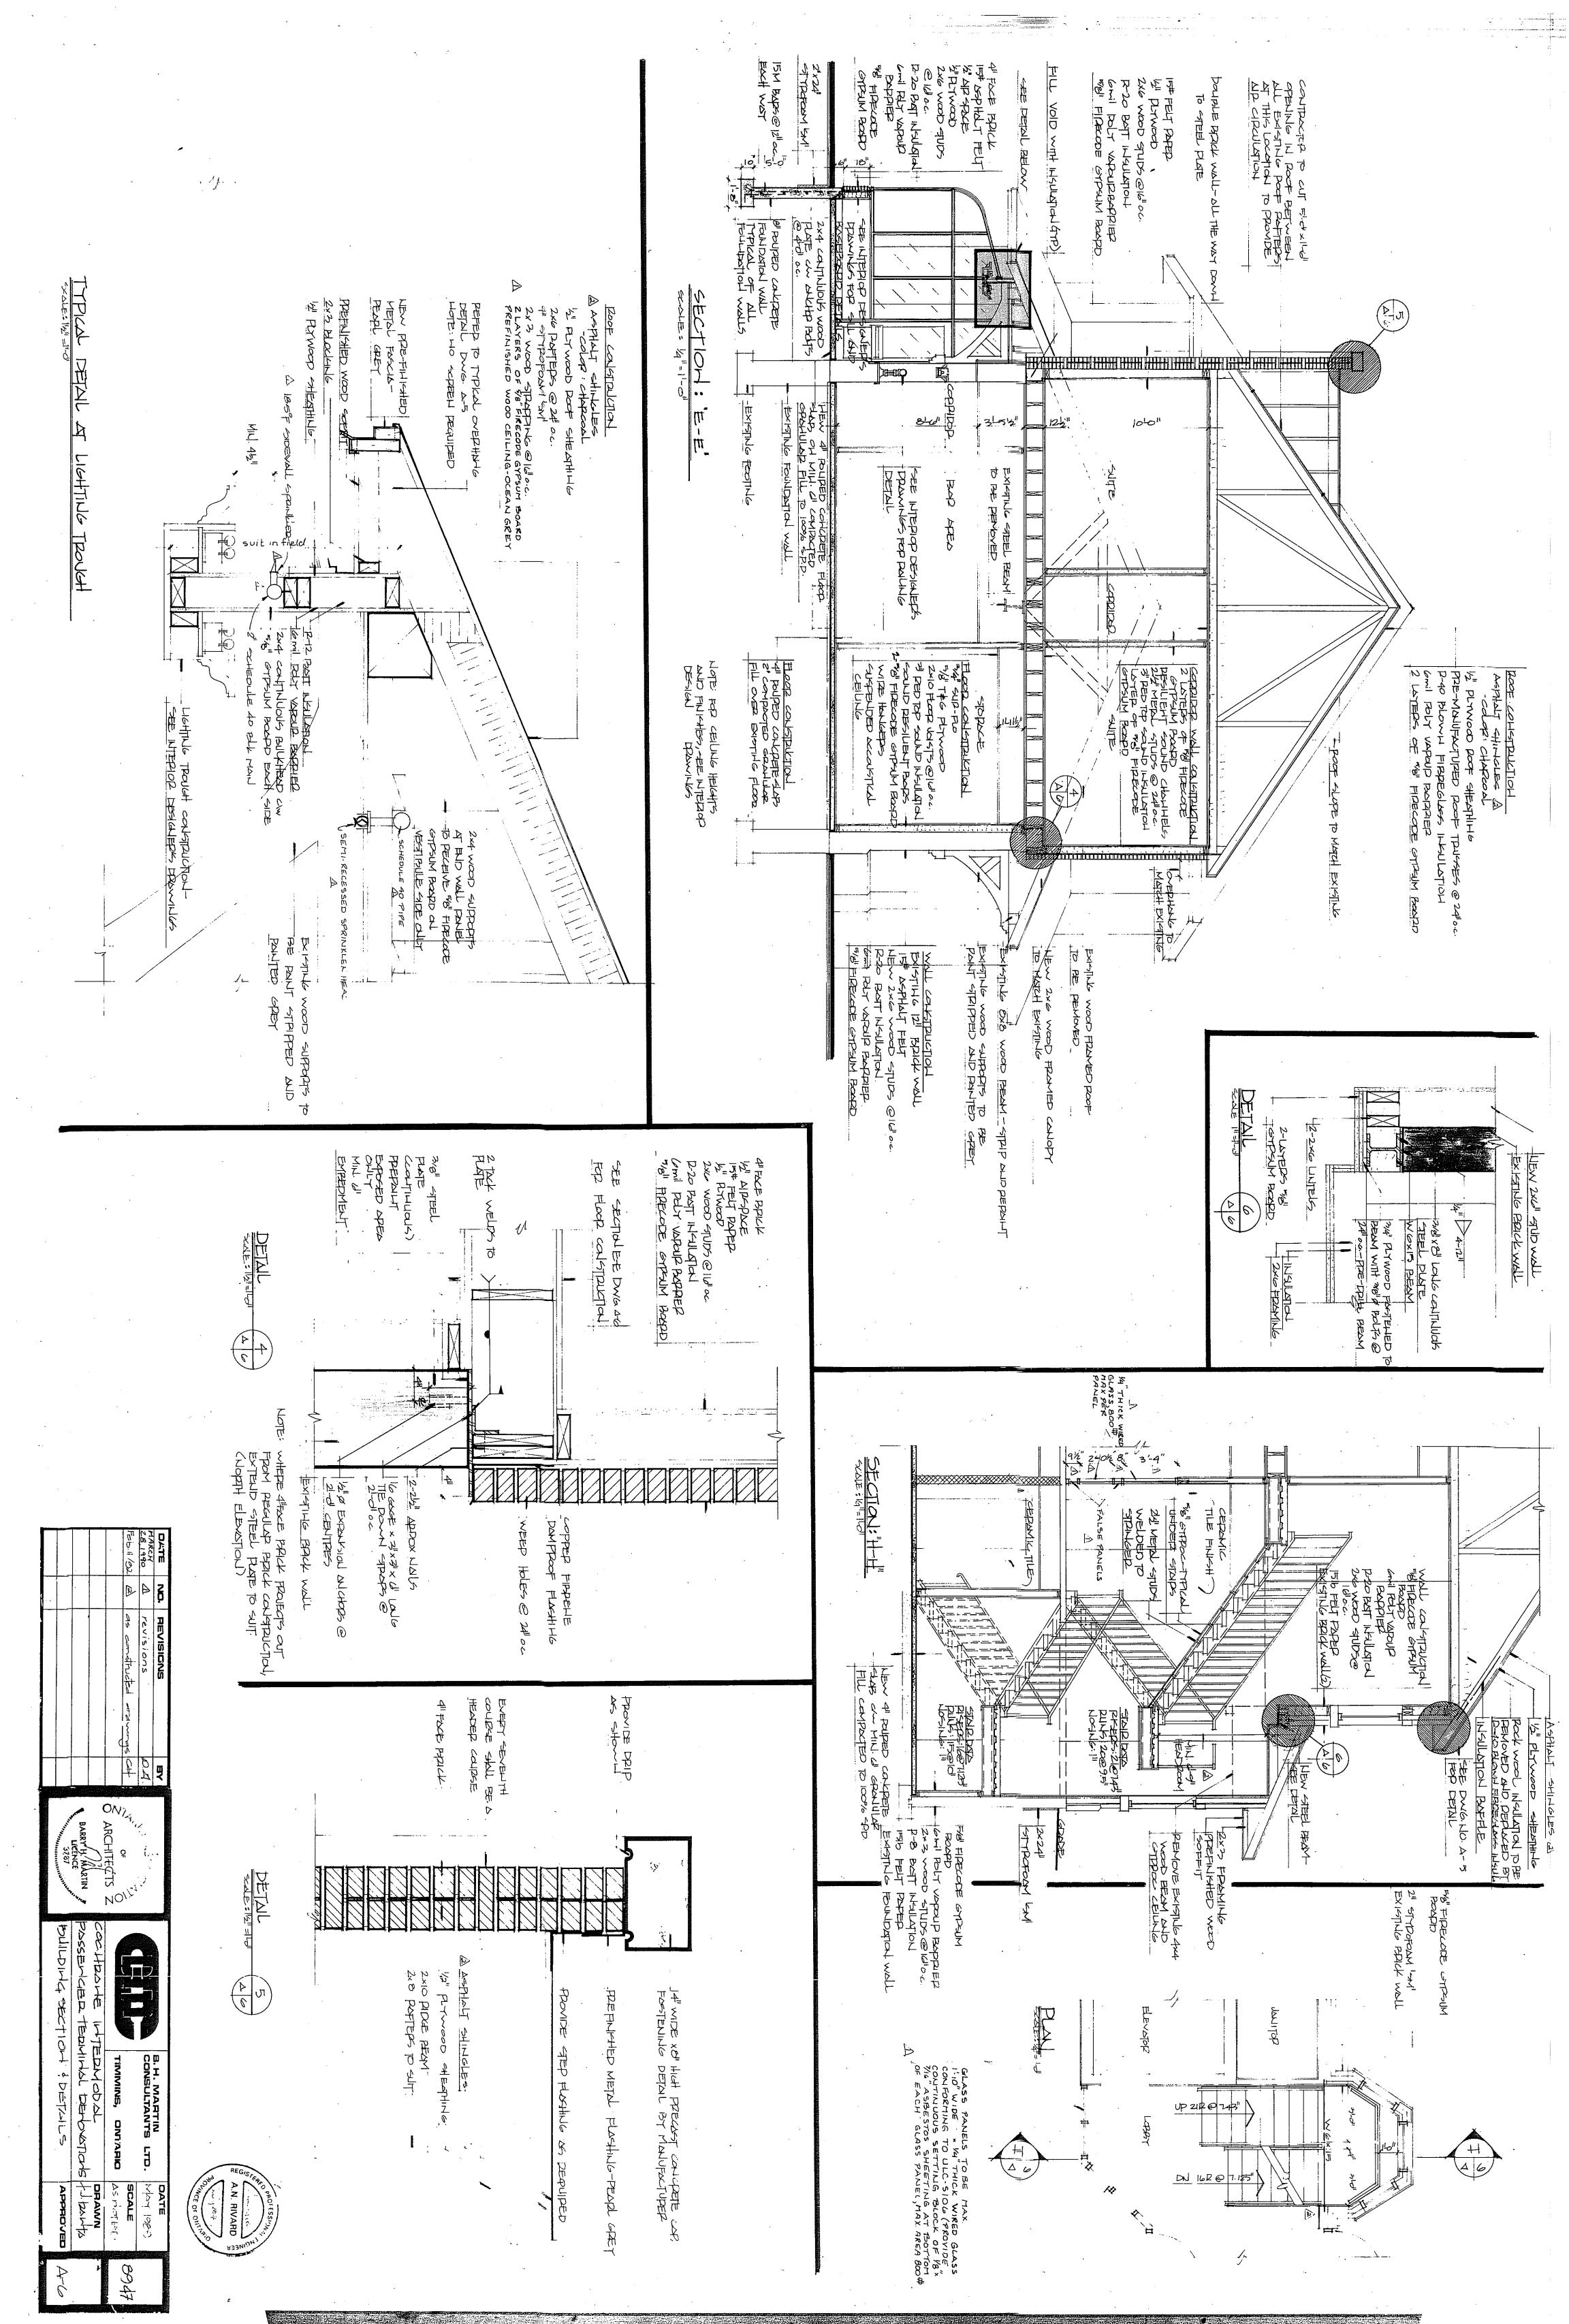
STORM PIPES UNDERGROUND




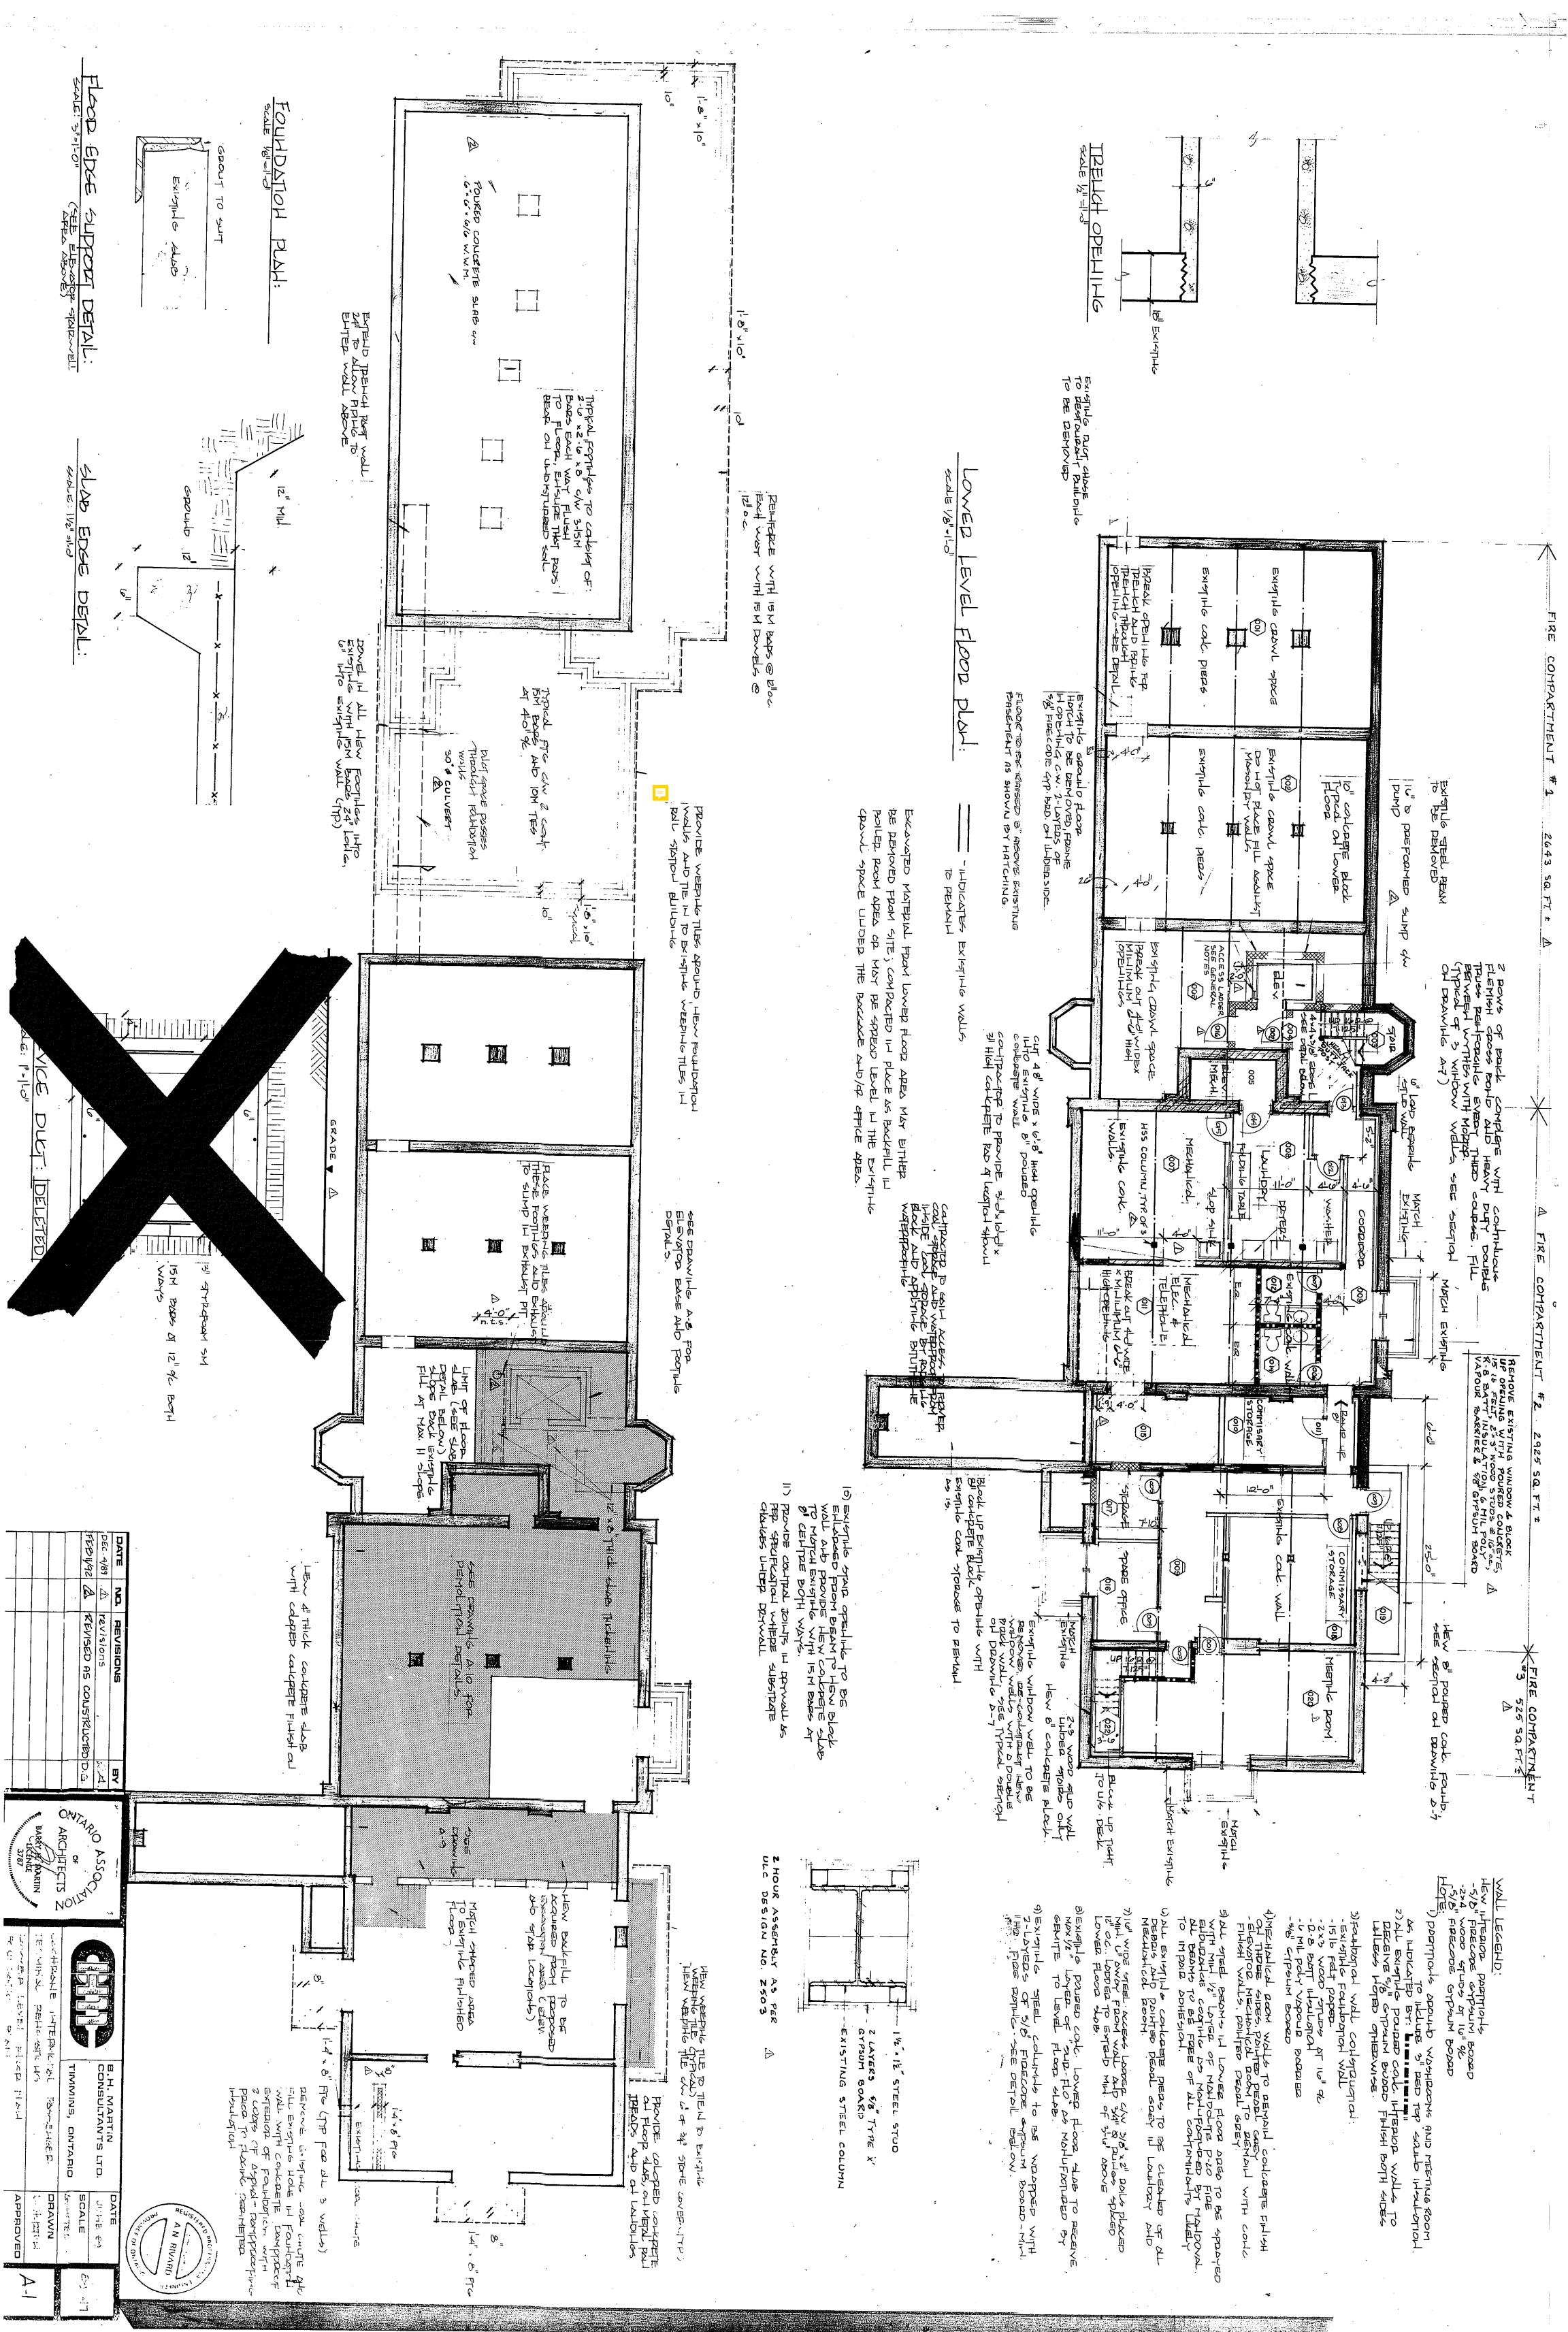

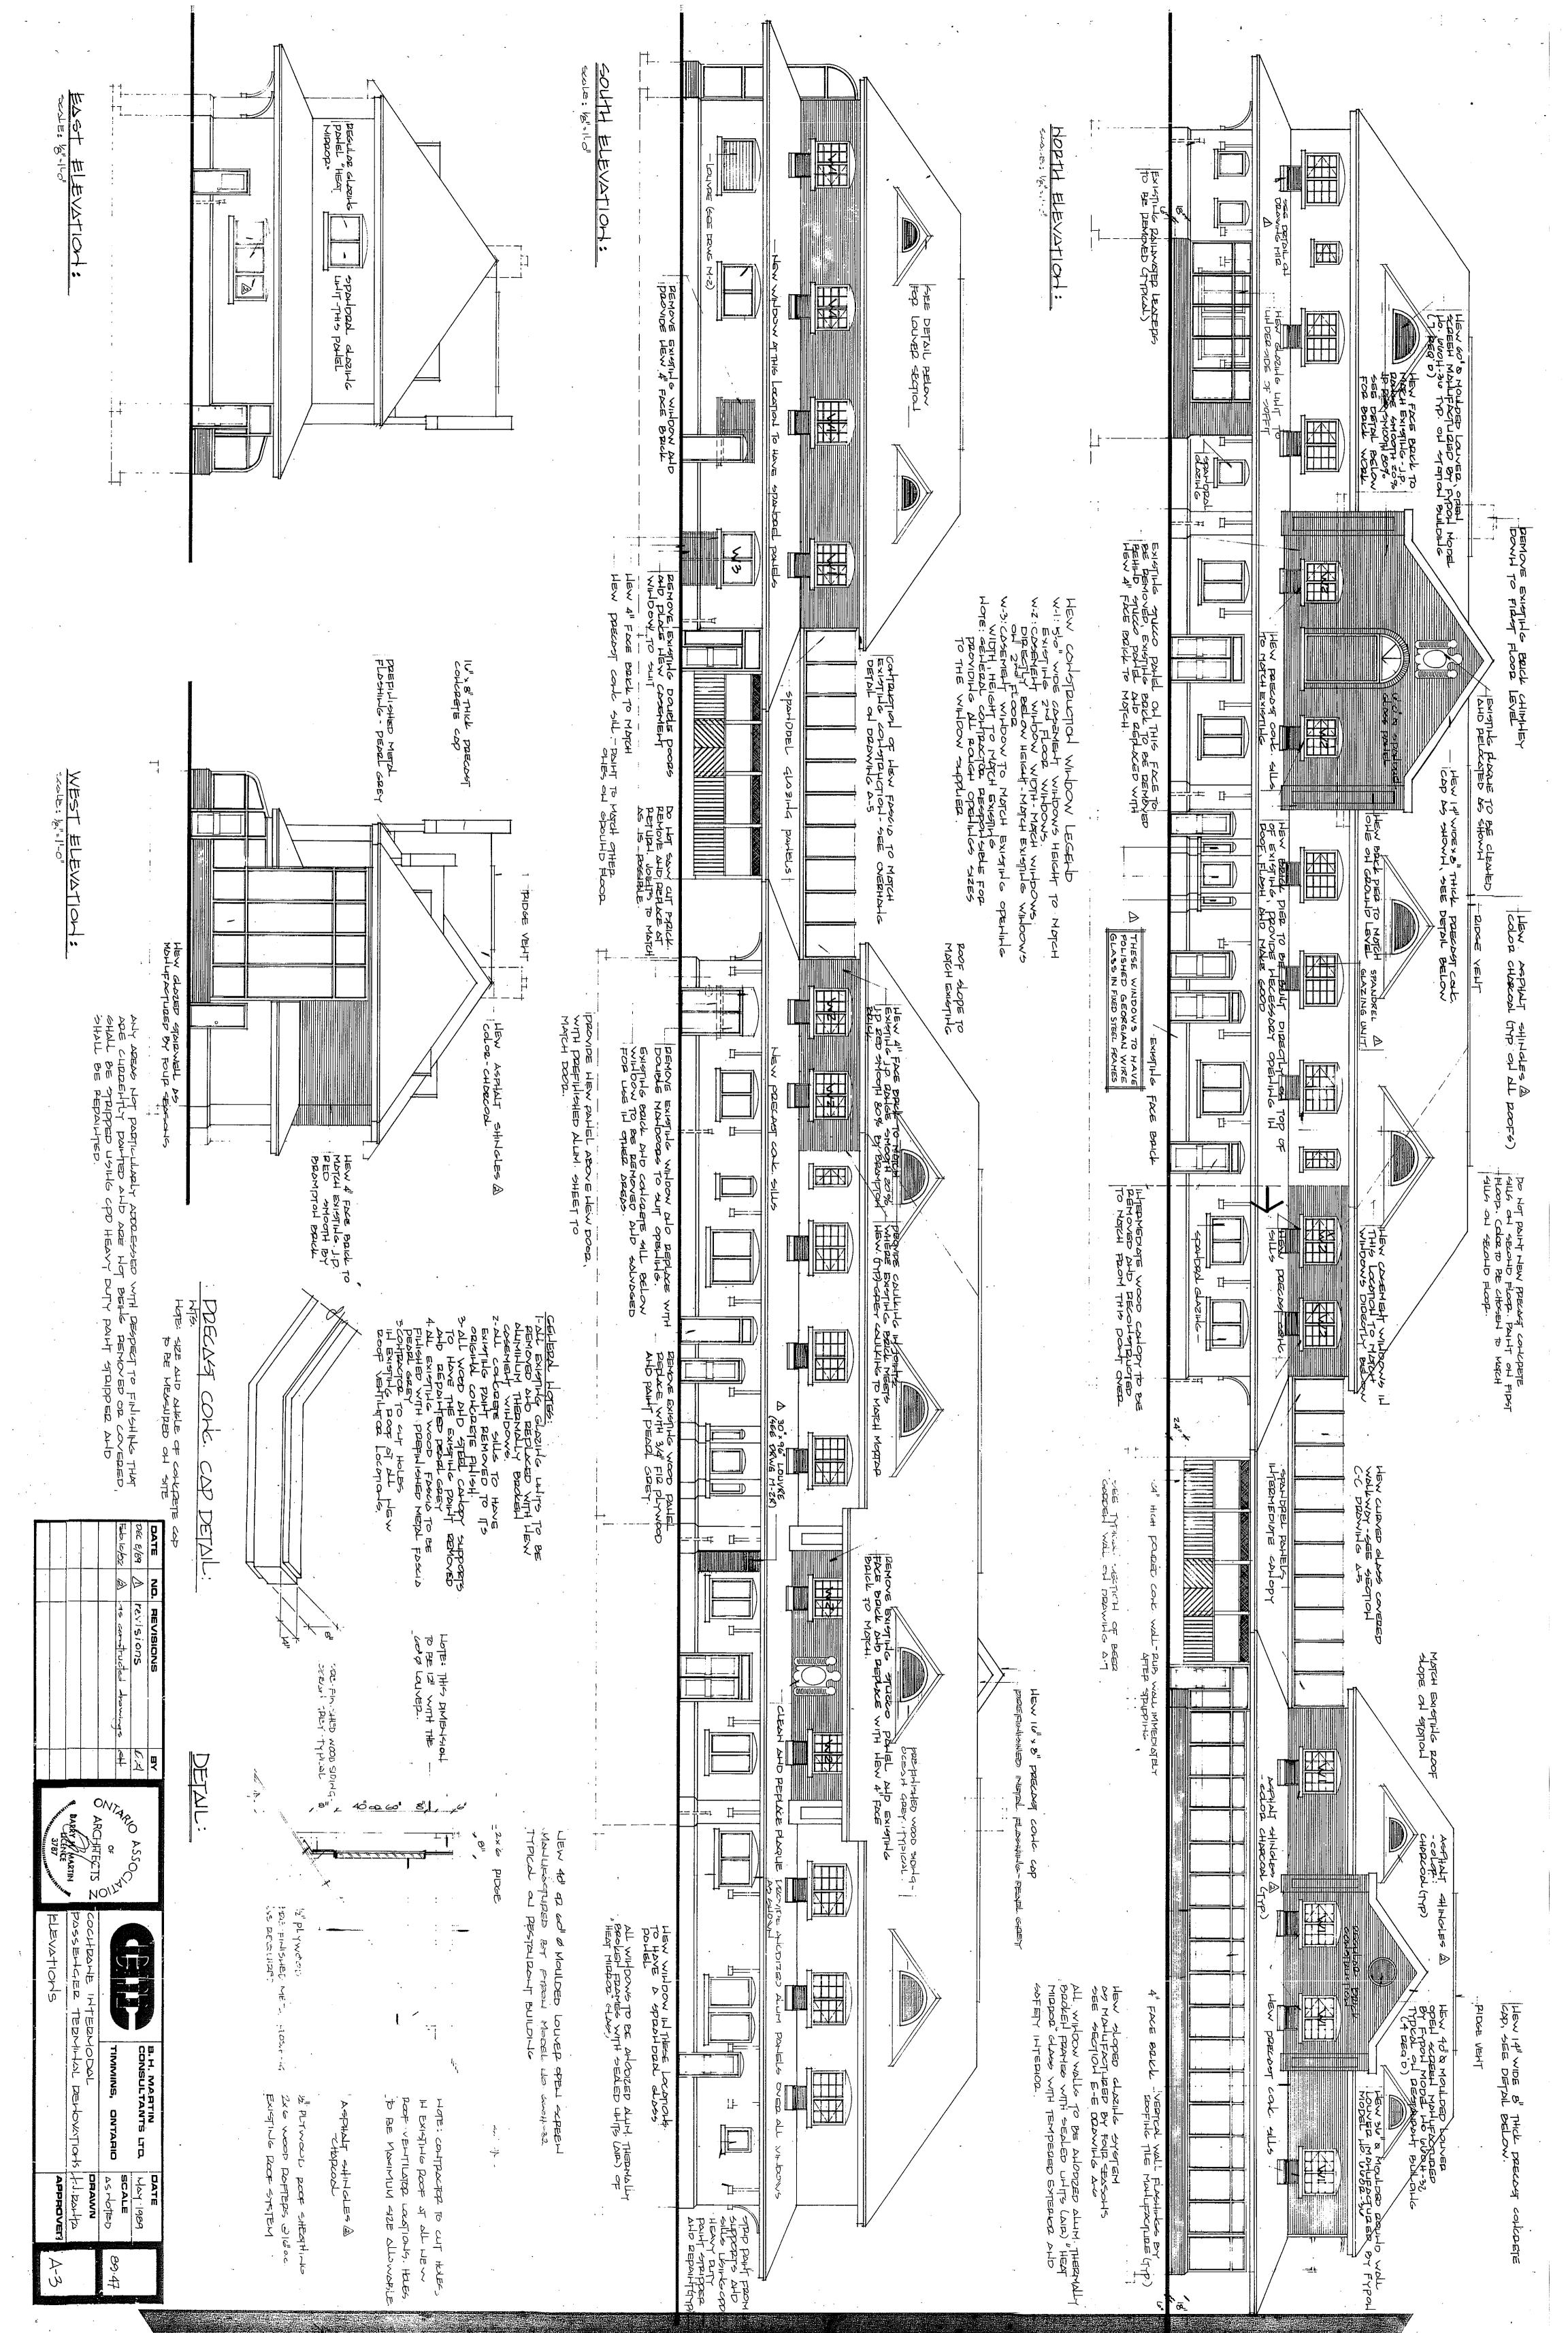


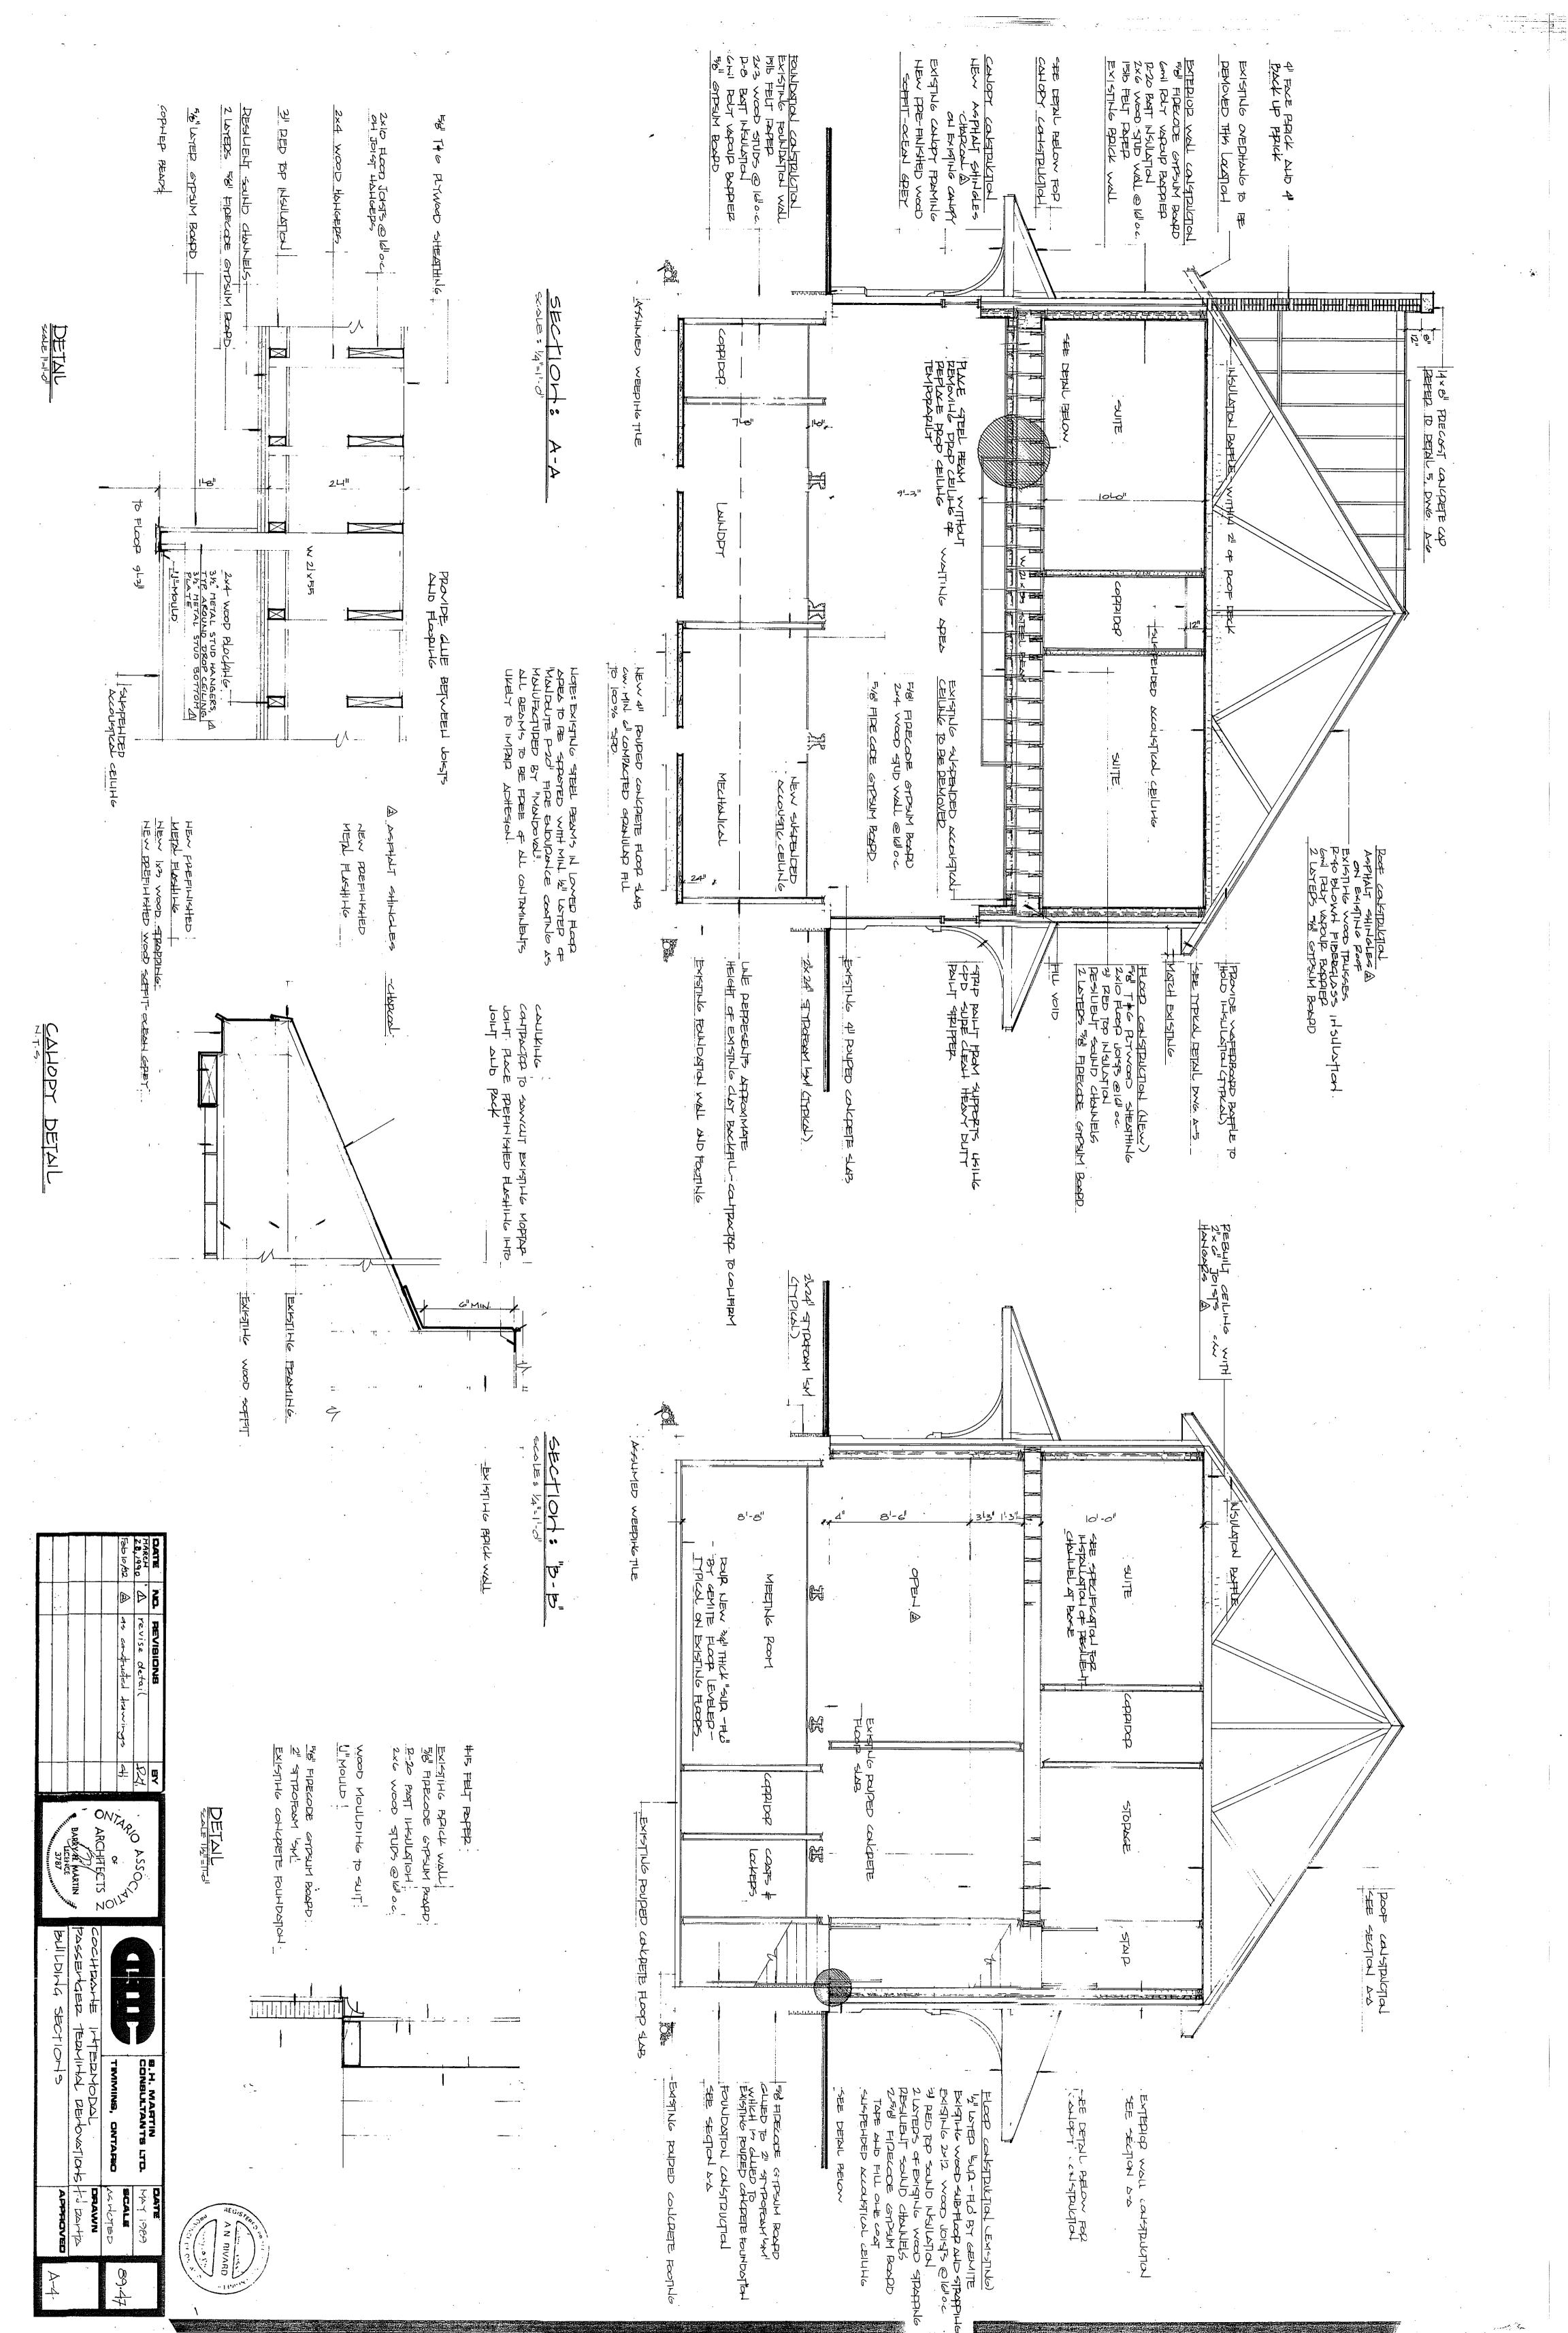


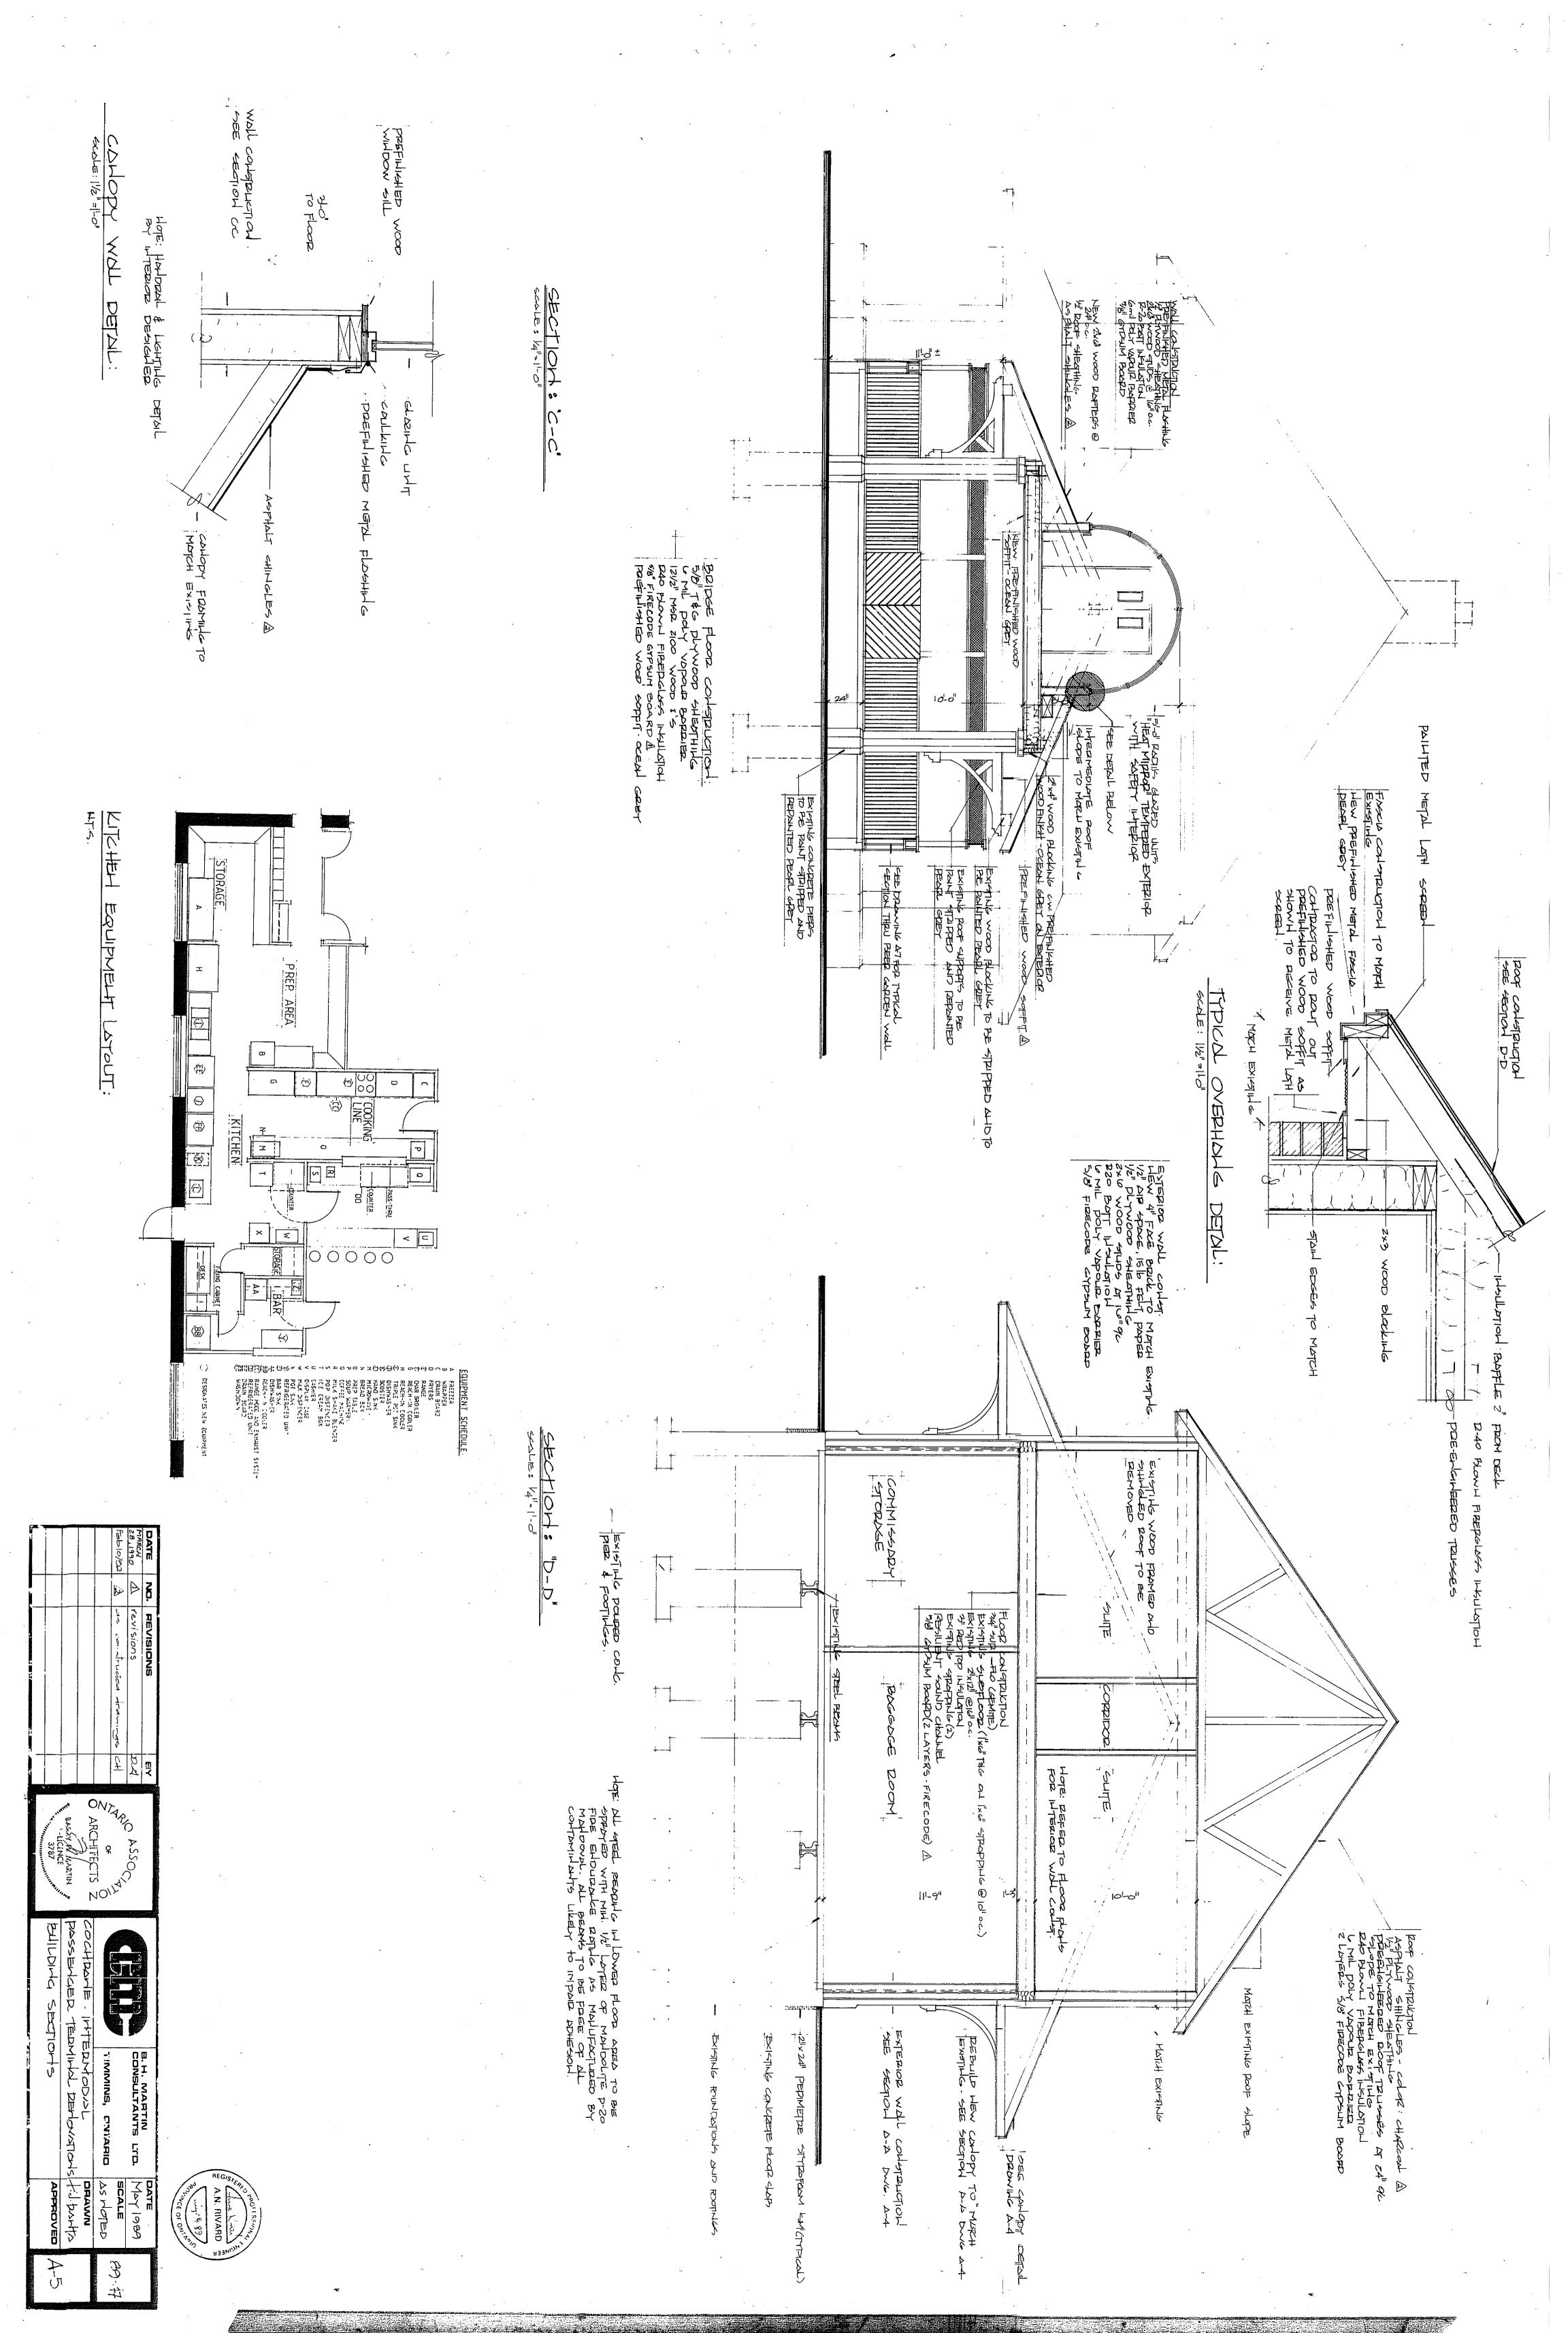

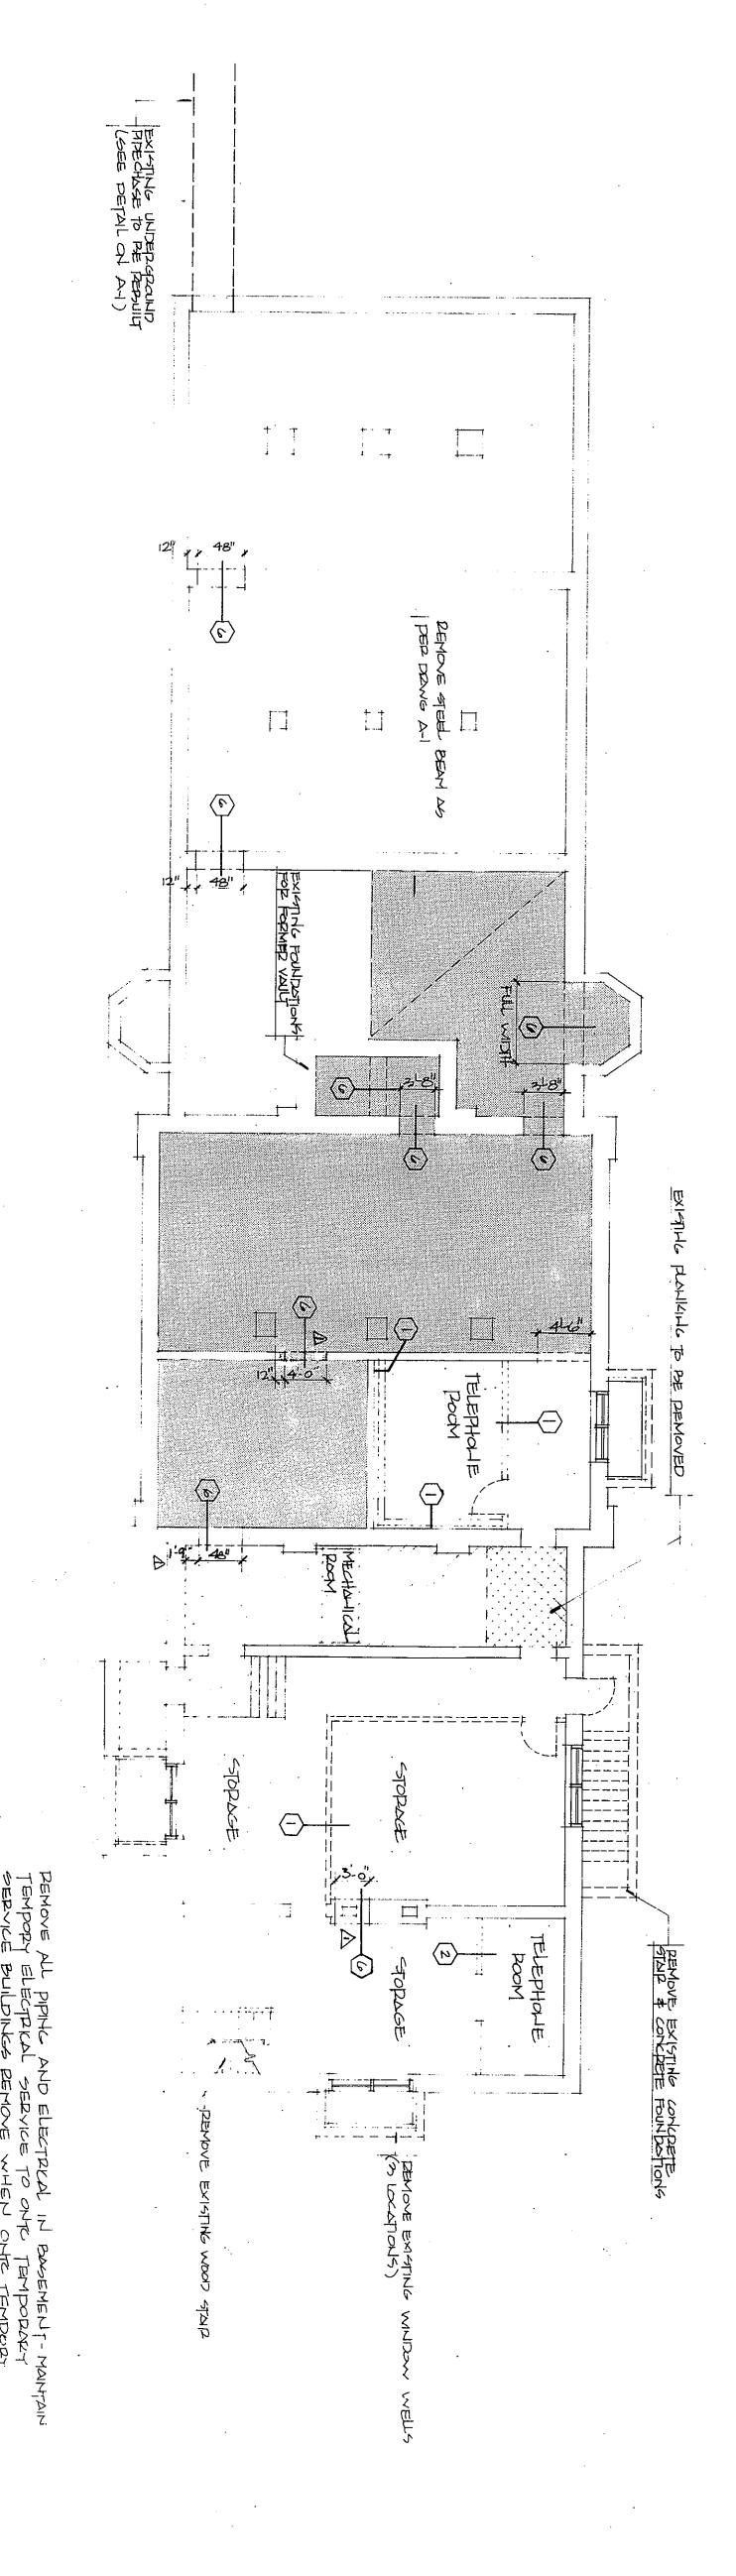


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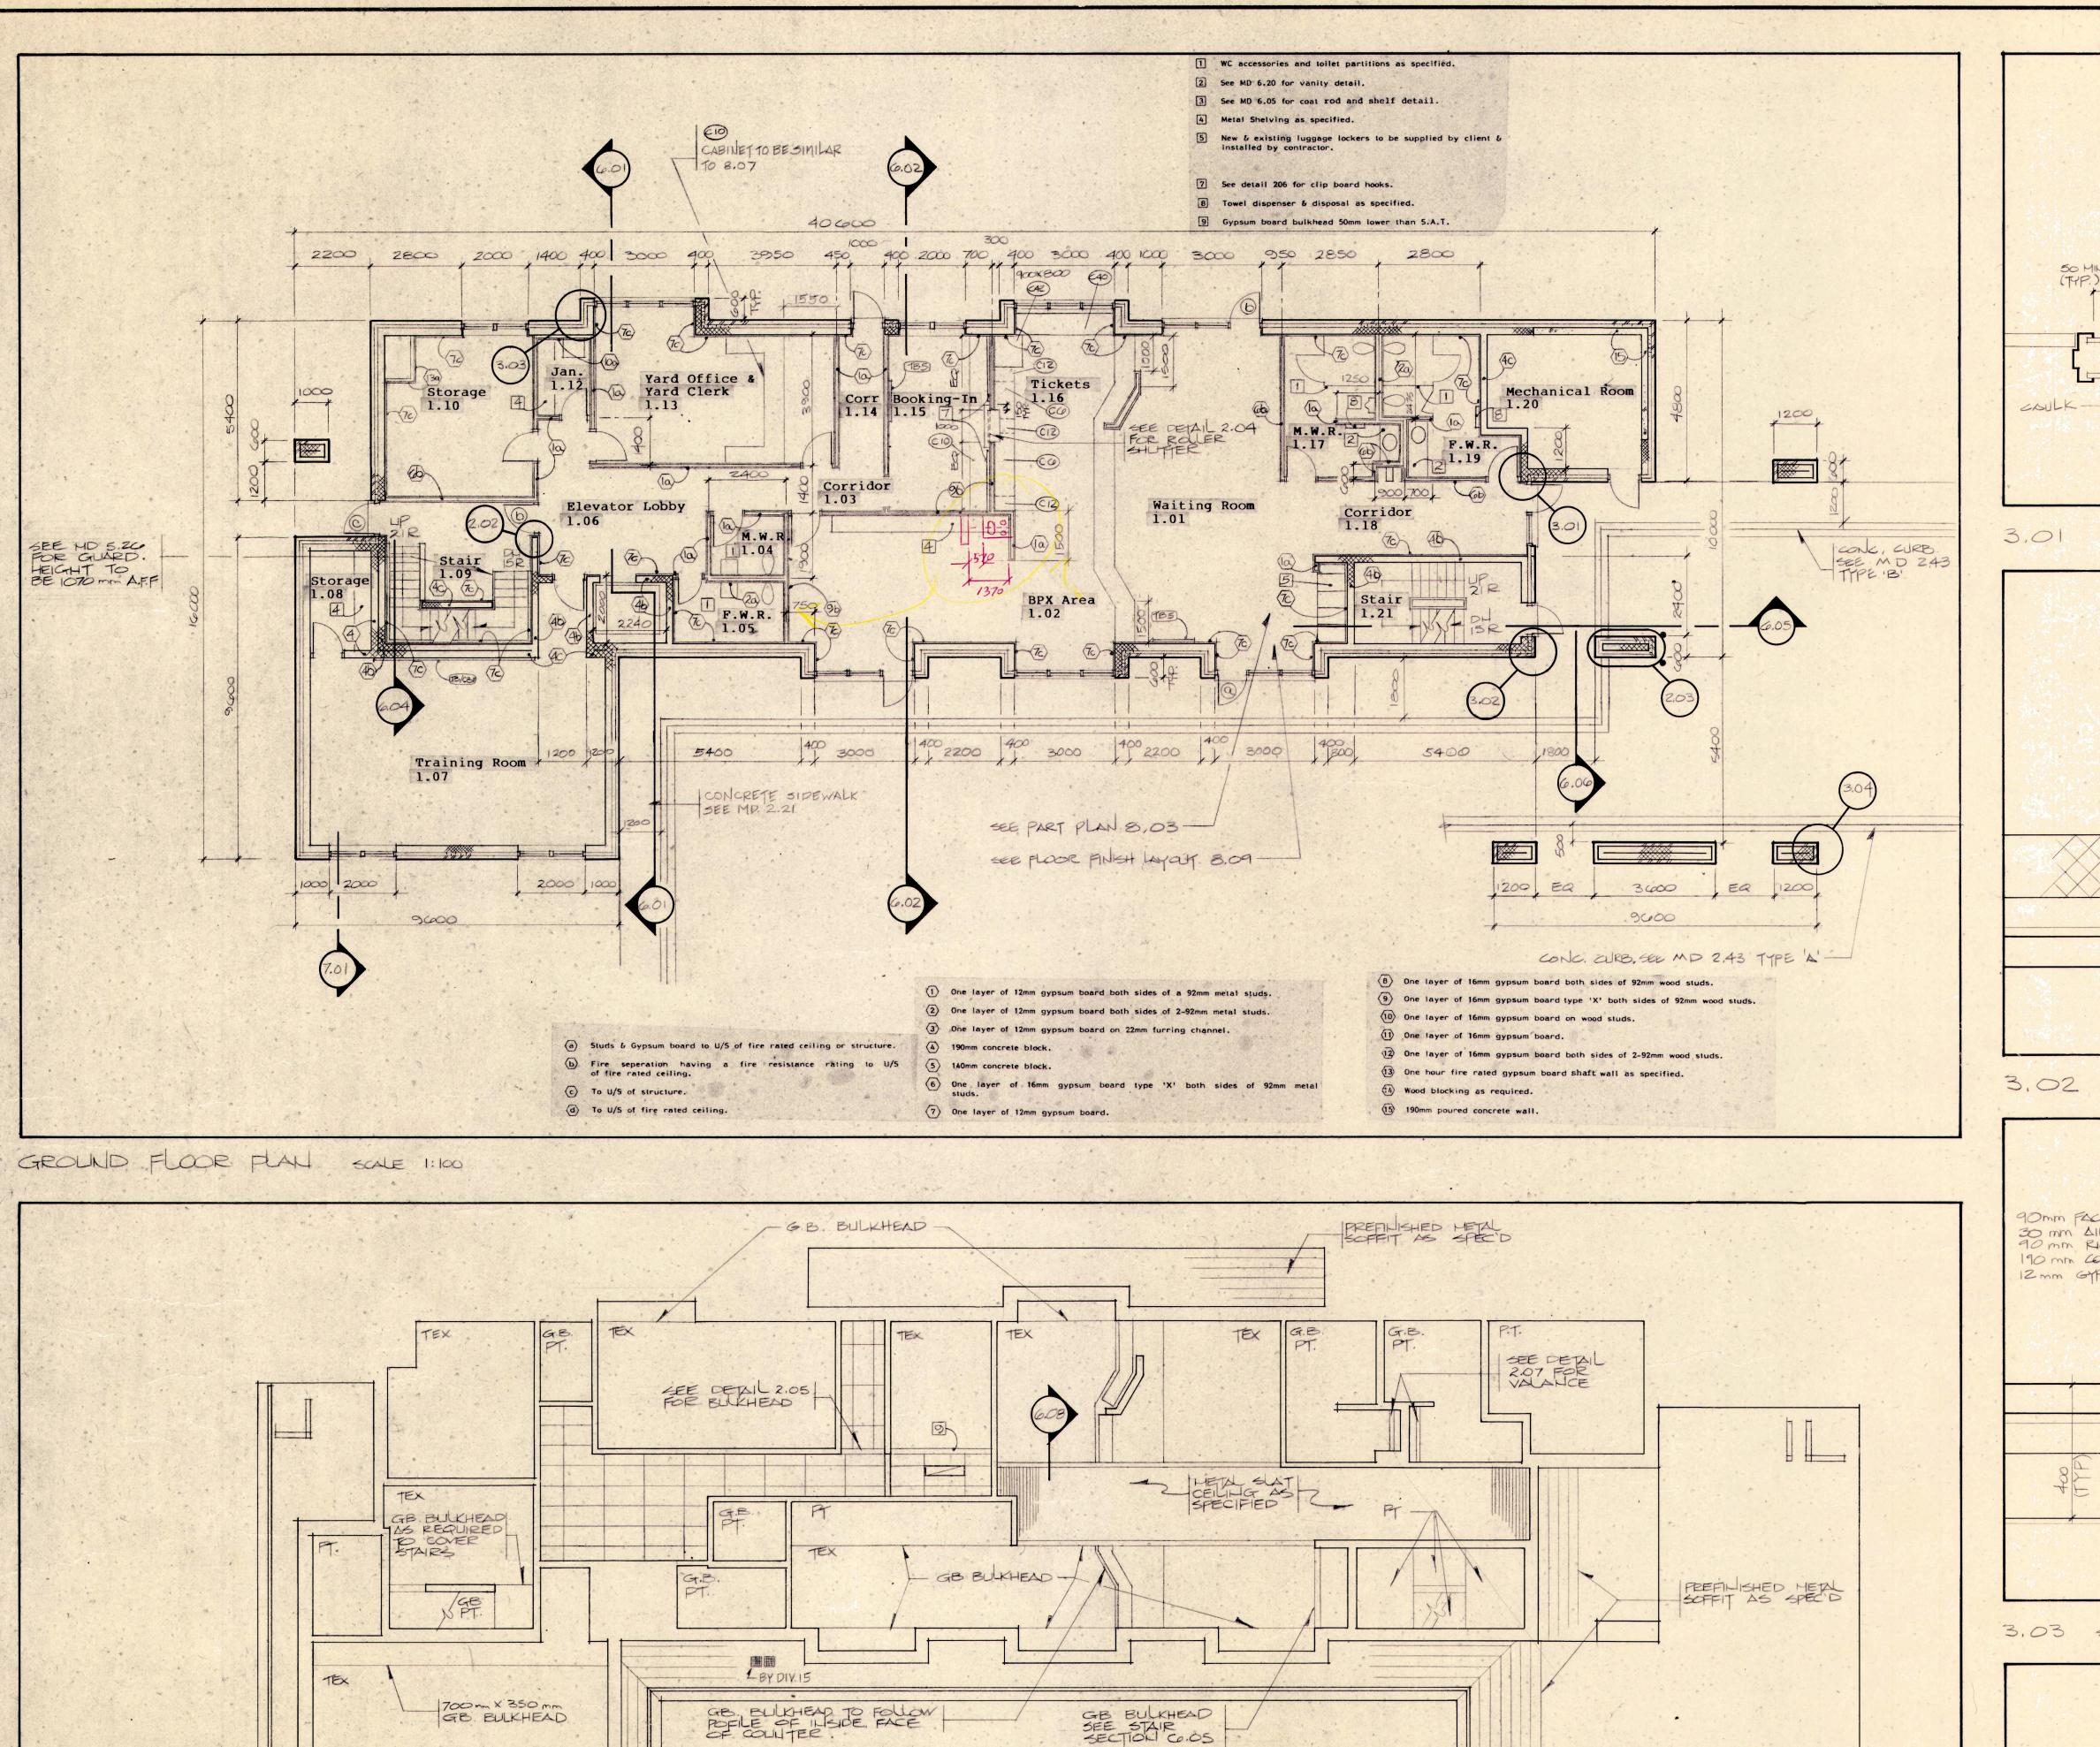
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DESCRIPTION OF DRAWING BASEMENT PLAN
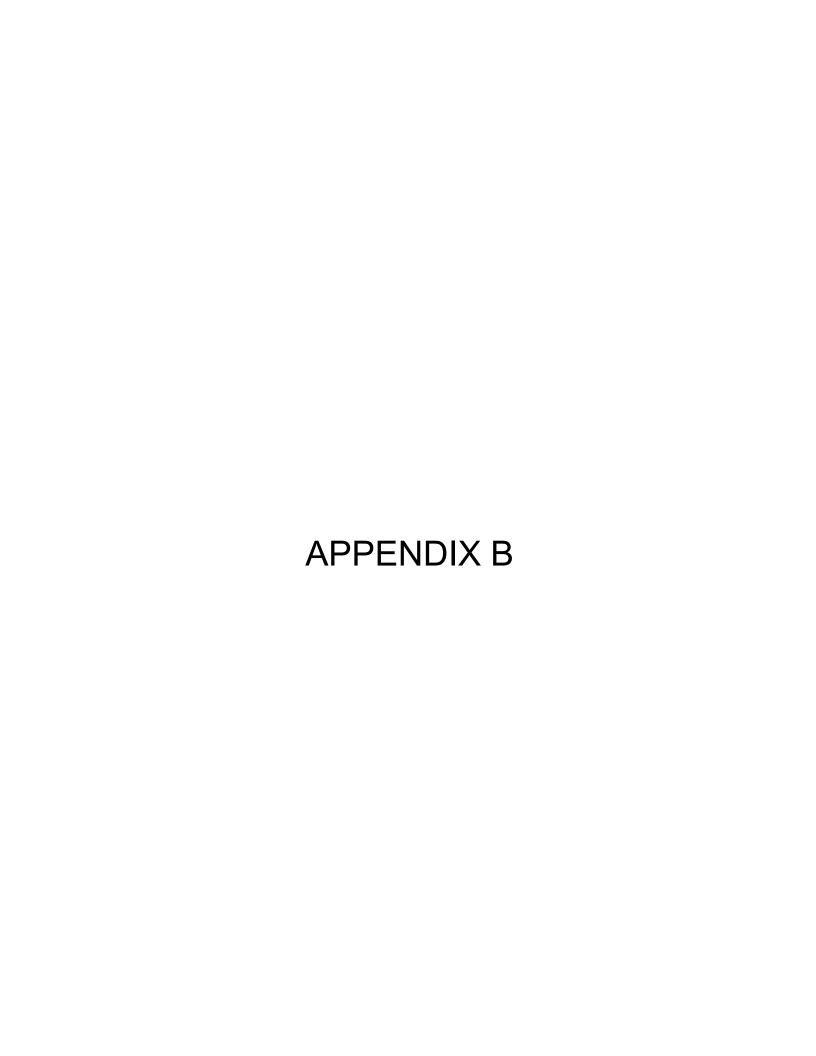
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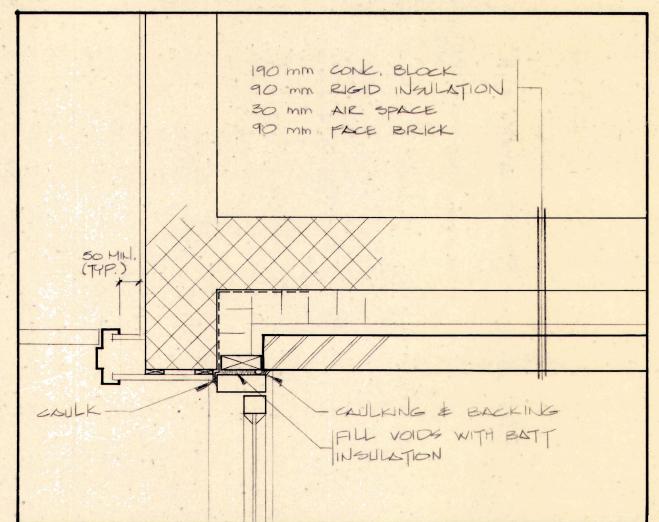
DRAWING NO.

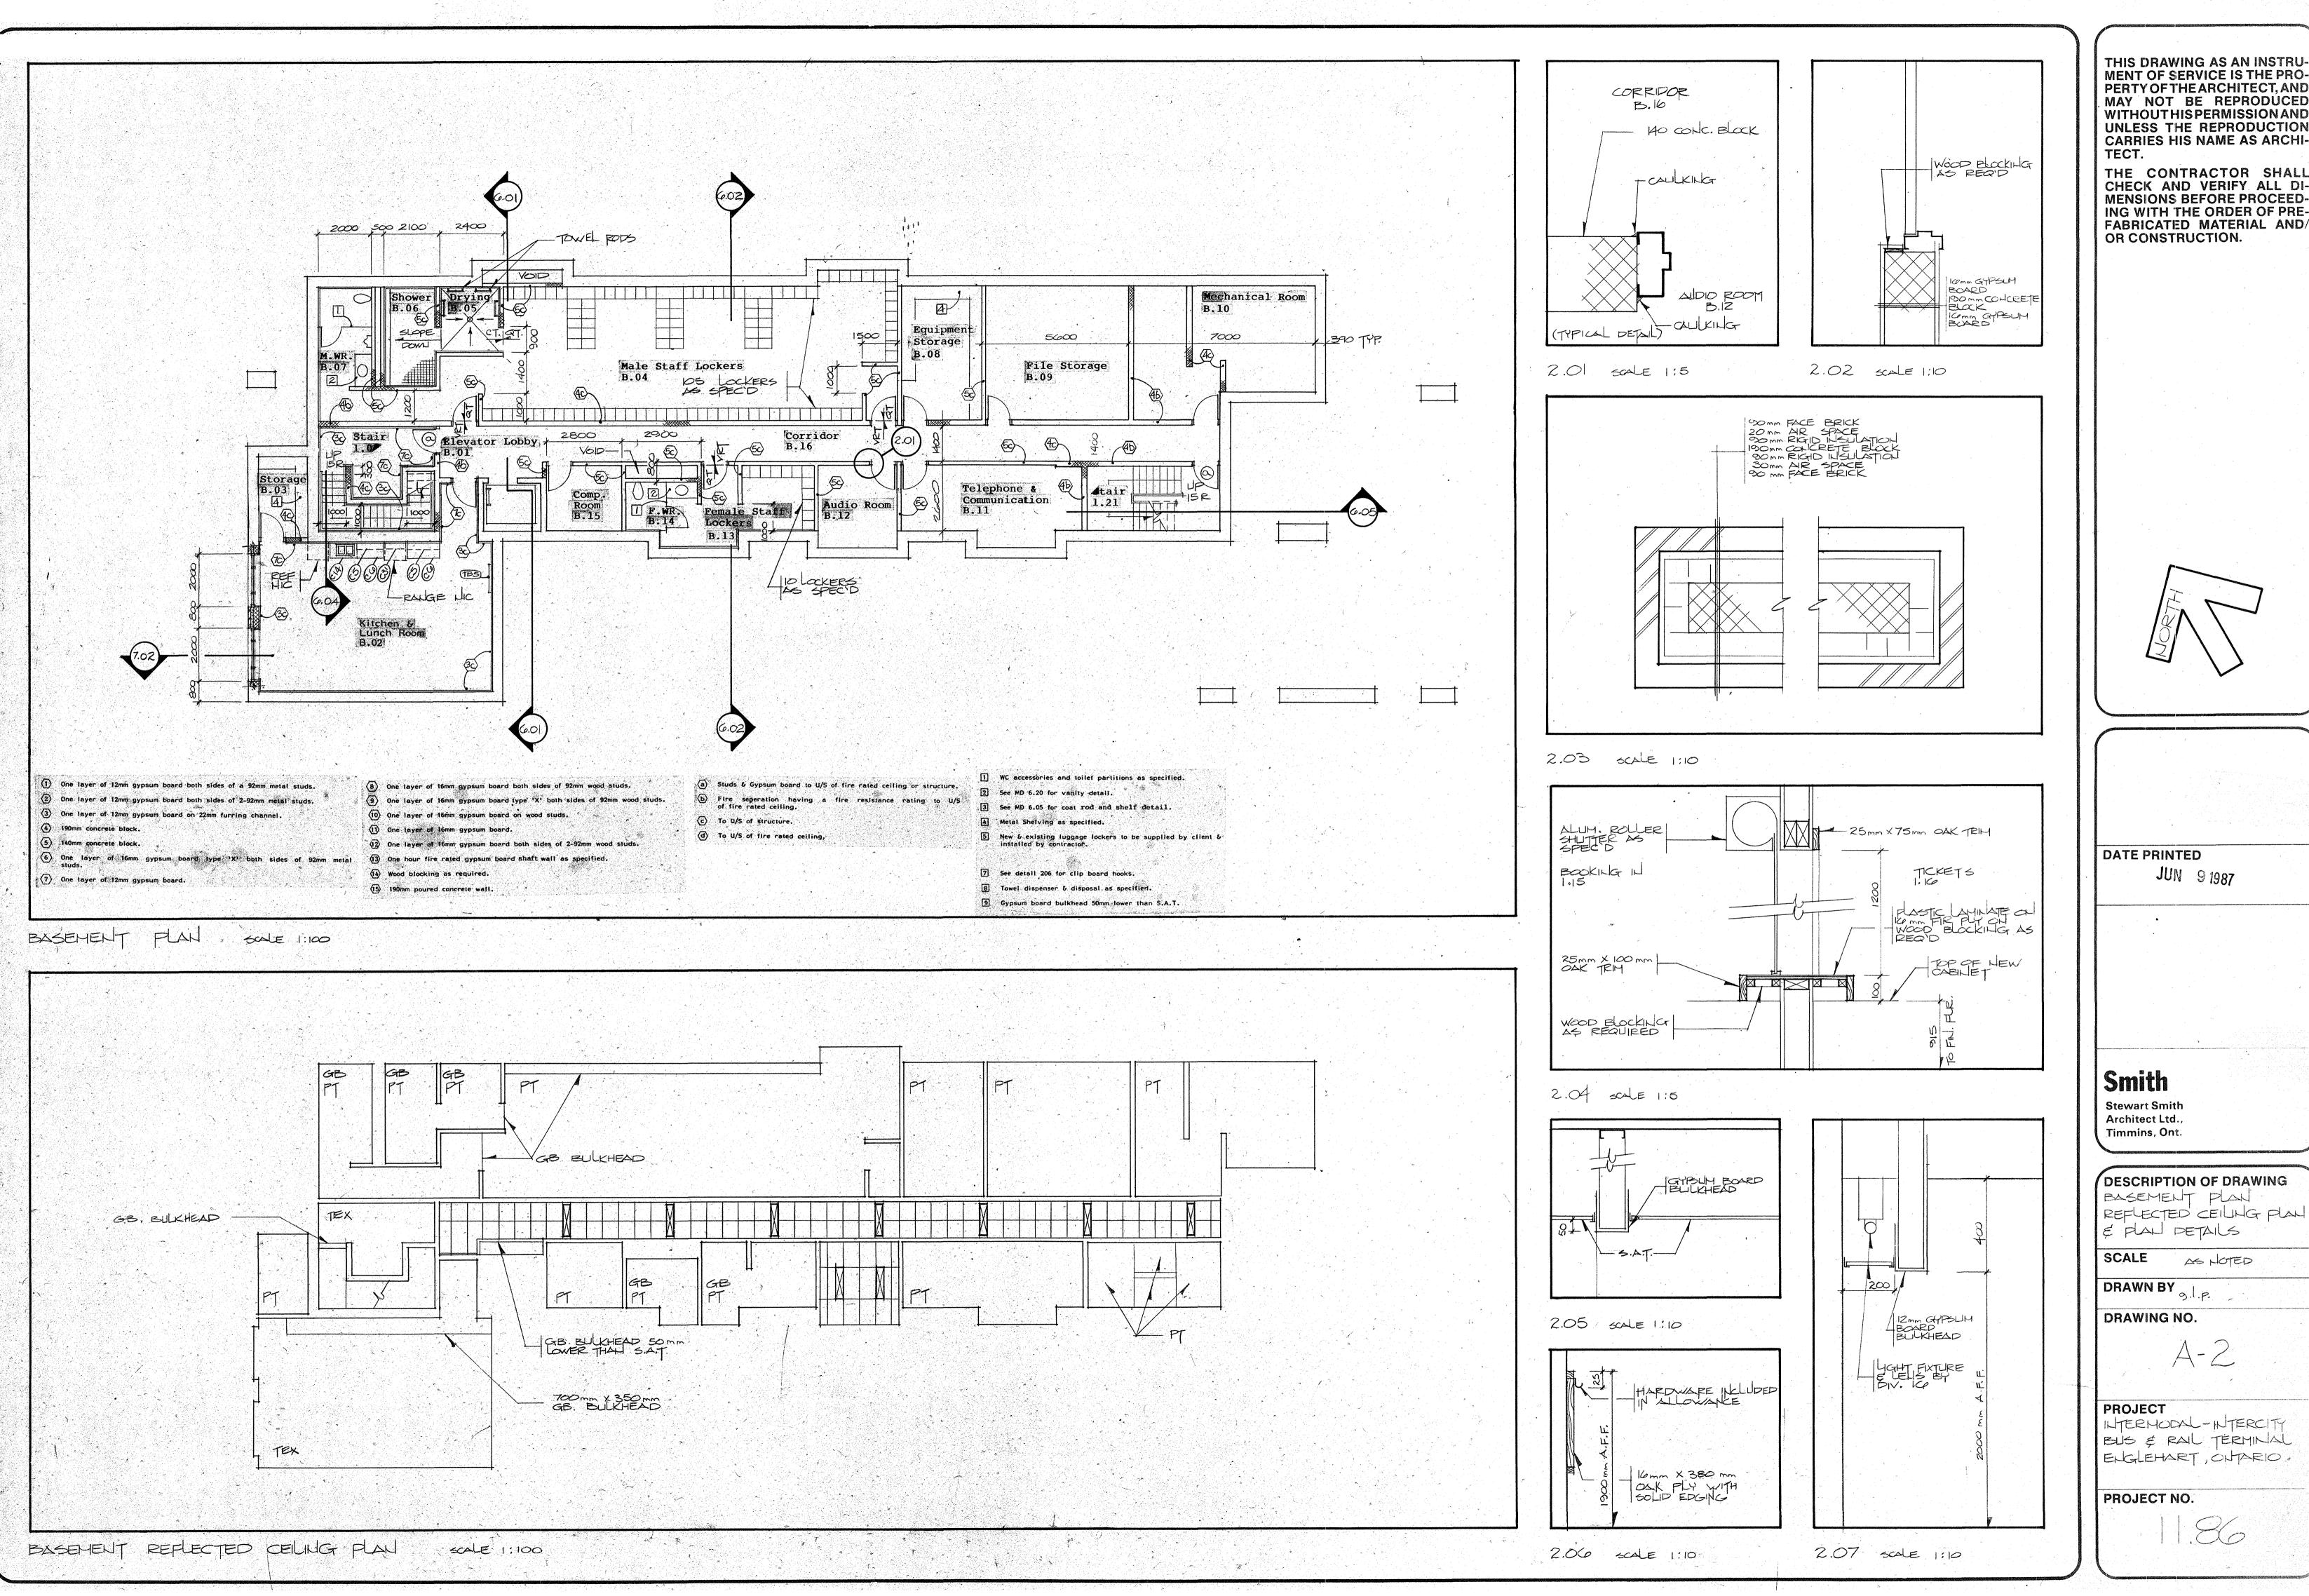INTERMODAL-INTERCITY BLS & RAIL TÉRMINIAL ENGLEHART, ONTARIO.




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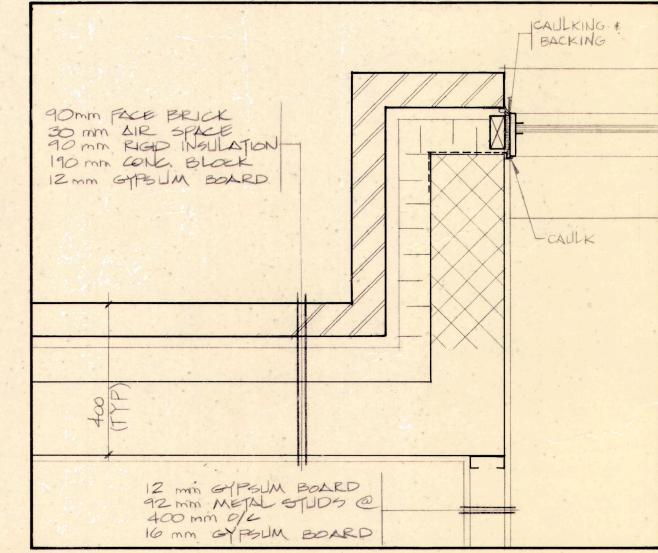
GROUND FLOOR REFLECTED CEILING PLAN SOME 1:100

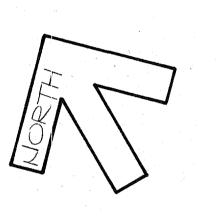


3,01 SCALE 1:10

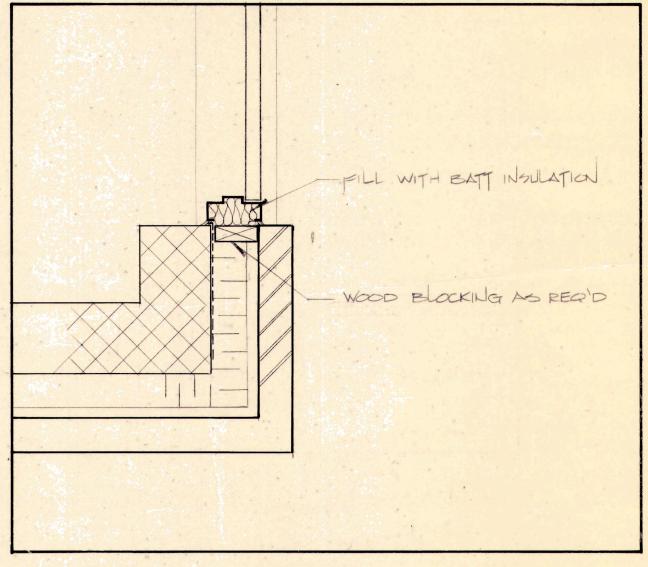

3,02 SCALE 1110




3.03 SCALE 1:10

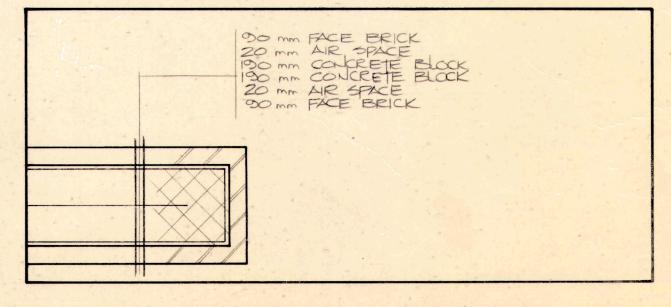

3.04 SCALE 1:20

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Smith

**Stewart Smith** 

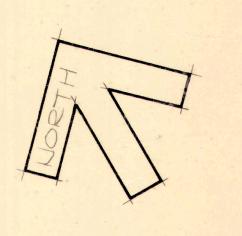Architect Ltd.,

Timmins, Ont. DESCRIPTION OF DRAWING

REFLECTED CEILING PLAN & PLAN DETAILS

GROUND FLOOR PLAN

SCALE AS NOTED

DRAWN BY


DRAWING NO.

PROJECT

INTERMODAL-INTERCITY BUS & RAIL TERMINAL ENGLEHART, ONTARIO:

PROJECT NO.



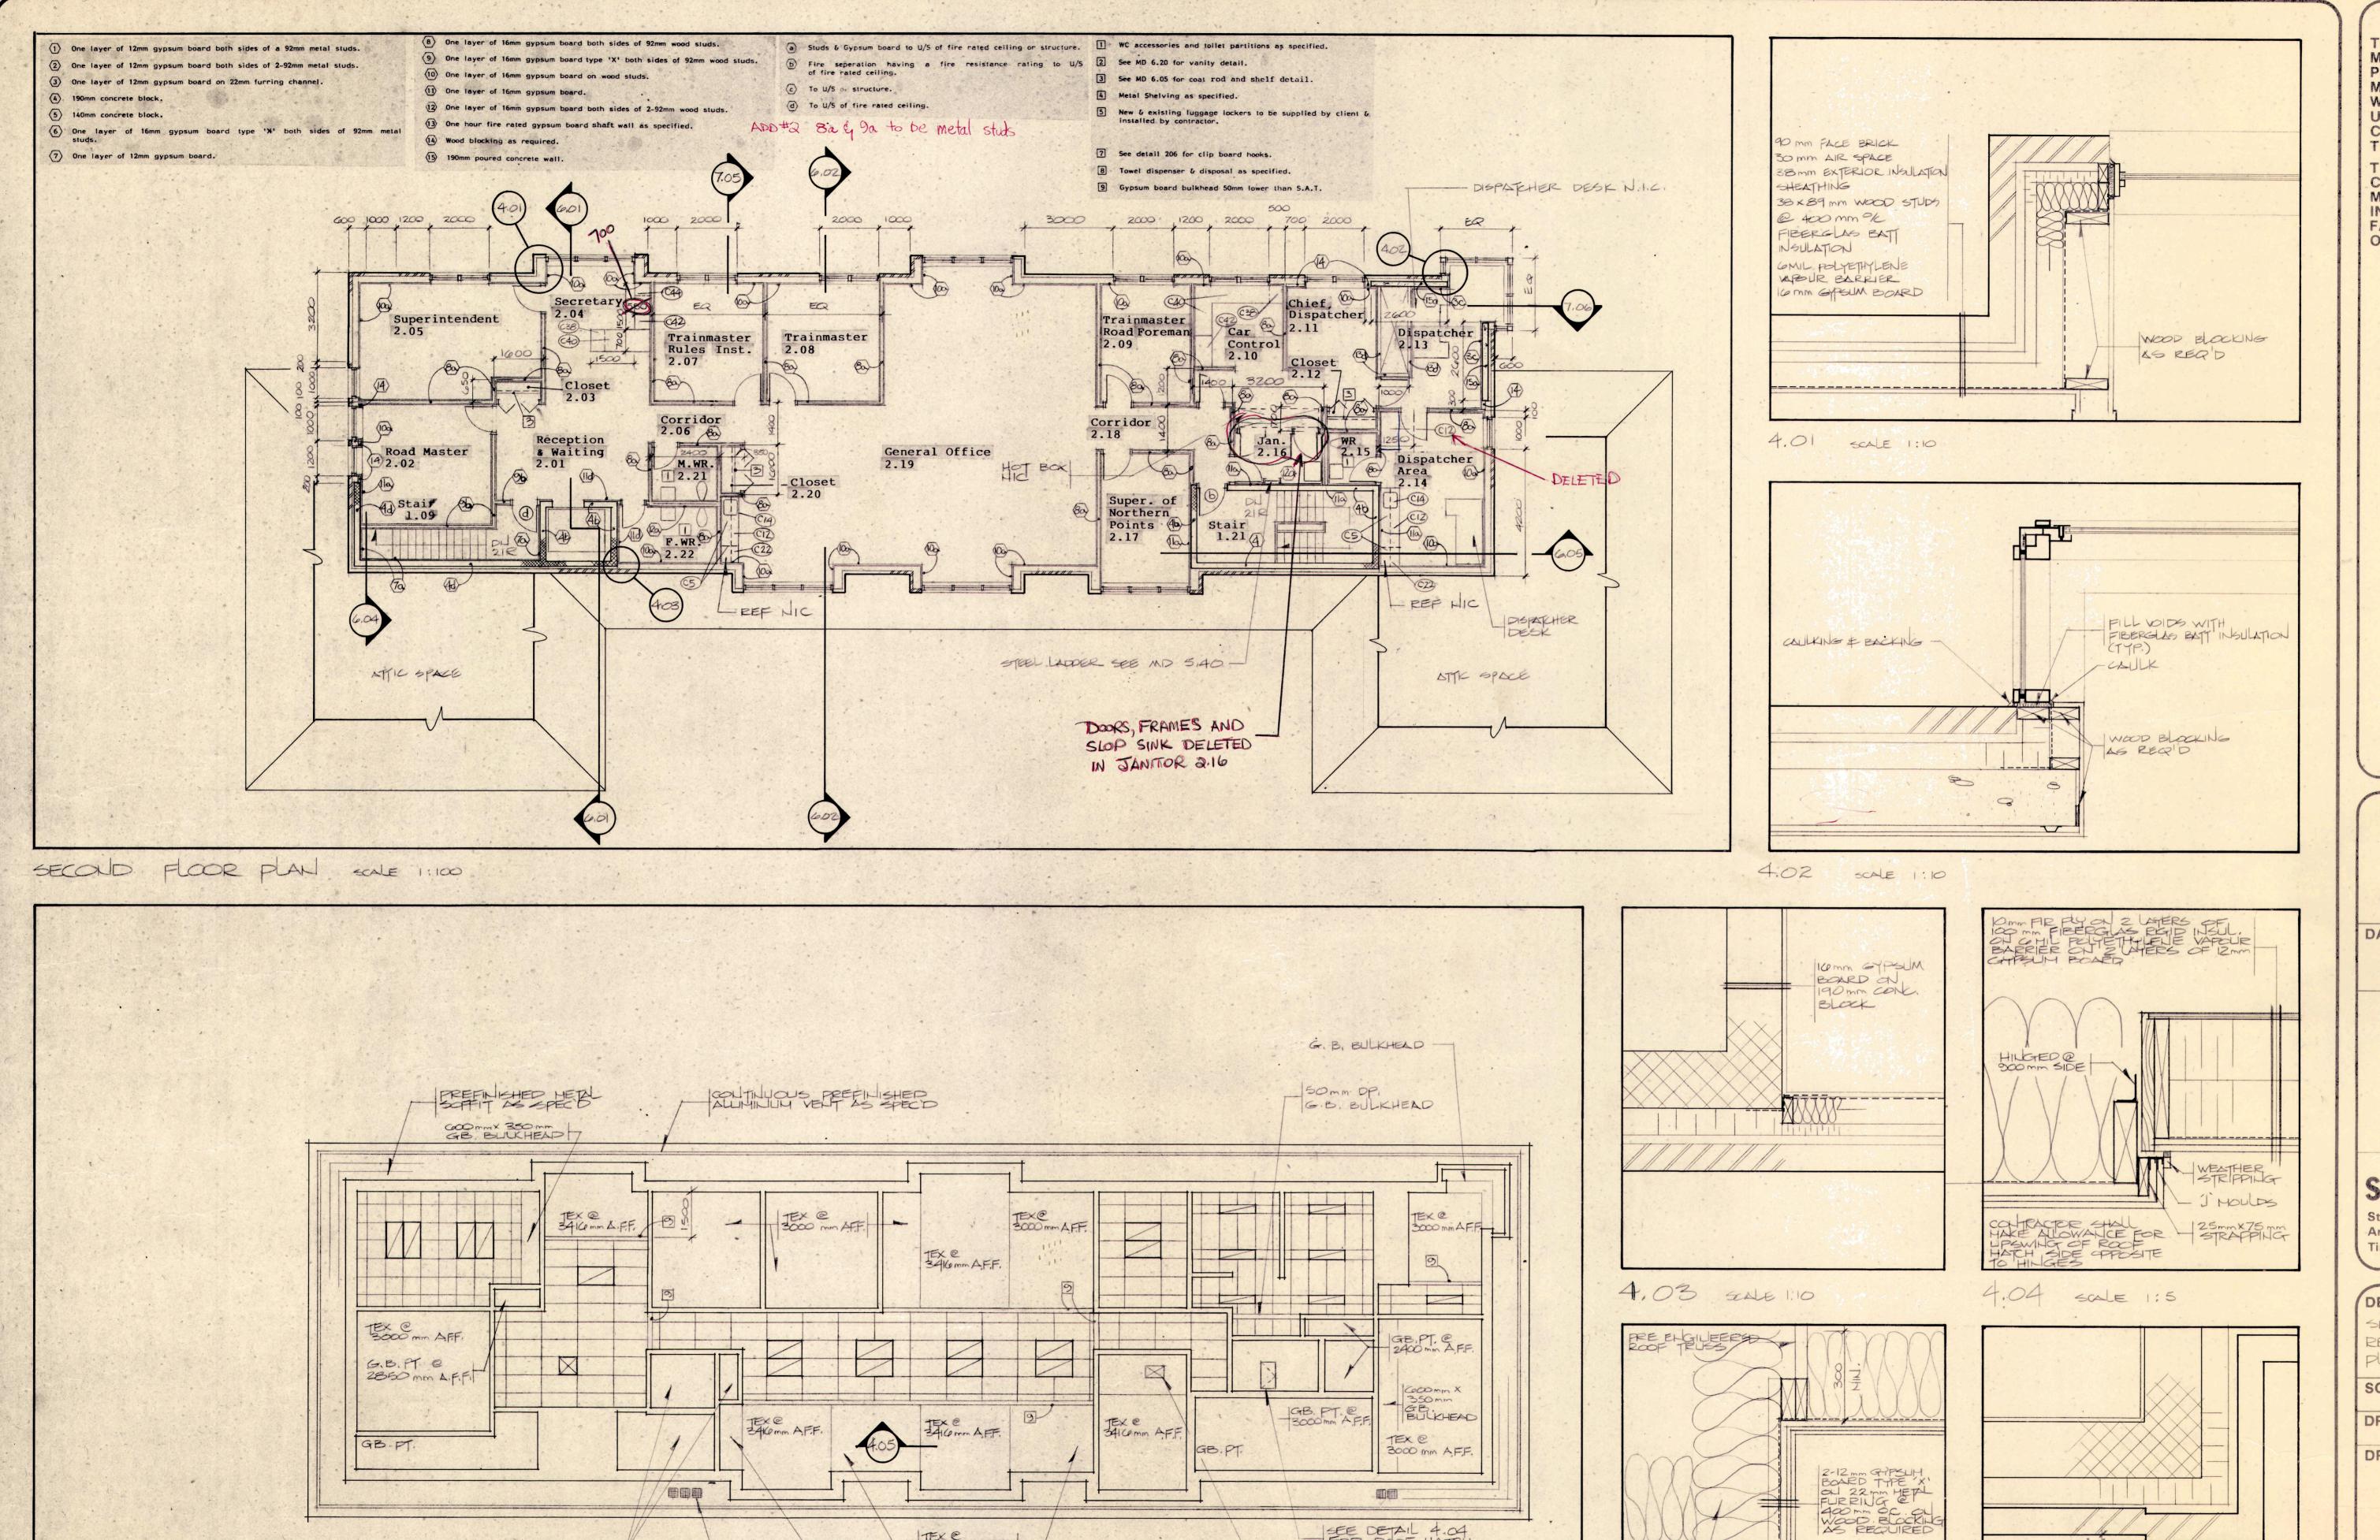

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FOR ROOF HATCH

4.05 scale 1:10

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DIV 15 (TYP.)


6.B. PT. @ 1 2400 mm AFF.

SECOND FLOOR REFLECTED CEILING PLAN SOME 1:100

TEX @ 3000 mm A.F.F.

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Smith

**Stewart Smith** Architect Ltd., Timmins, Ont.

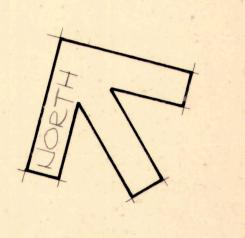DESCRIPTION OF DRAWING

SECOND FLOOR PLAN REFLECTED CEILING PLAN & PLAN DETAILS

SCALE AS NOTED

DRAWN BY

DRAWING NO.

PROJECT


LITERMODAL - INTERCITY BUS & RAIL TERMINAL ENGLEHART, ONTARIO


PROJECT NO.

400


4.06 SCALE 1:10



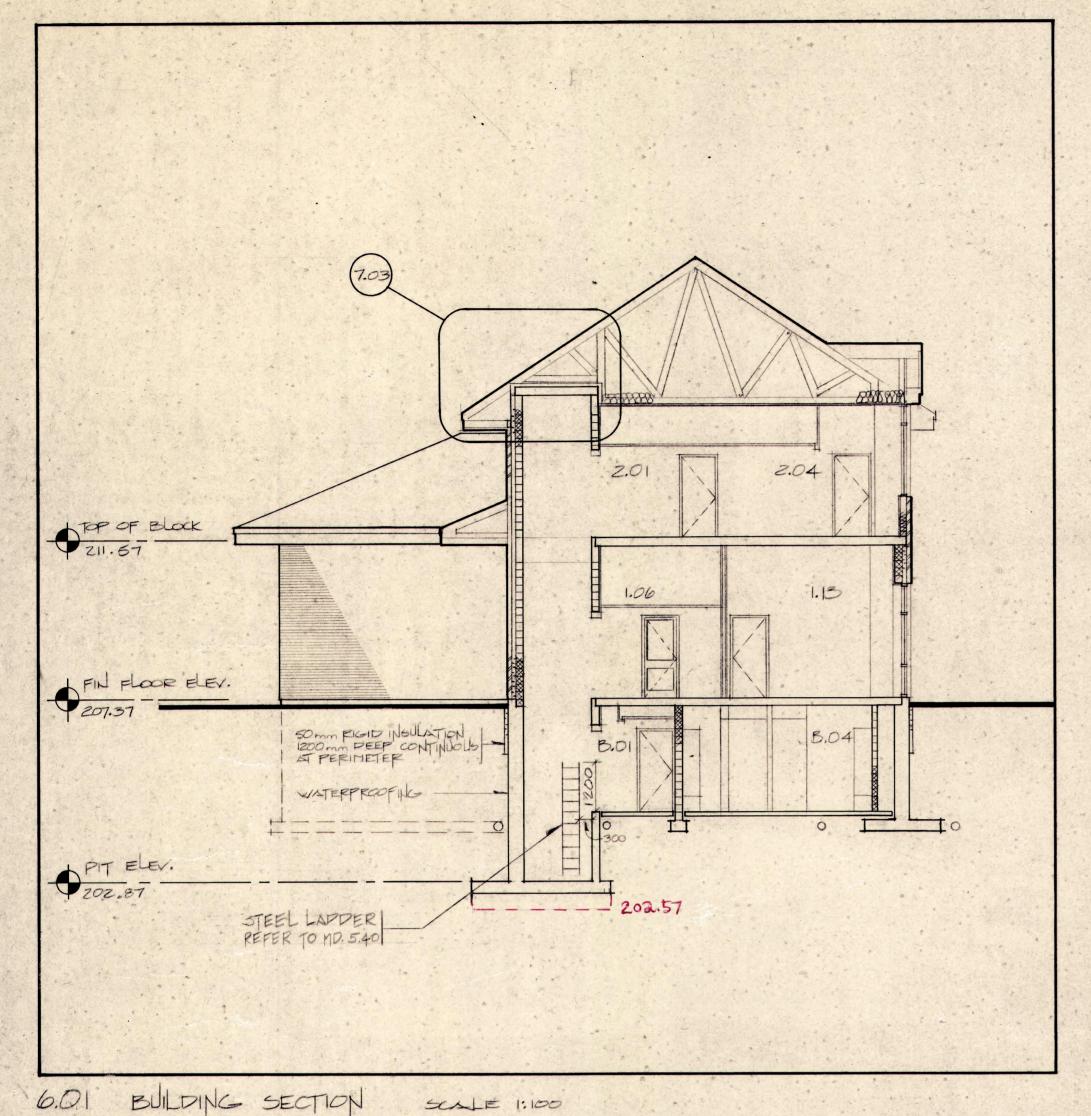


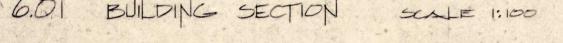


6.04 STAIR SECTION

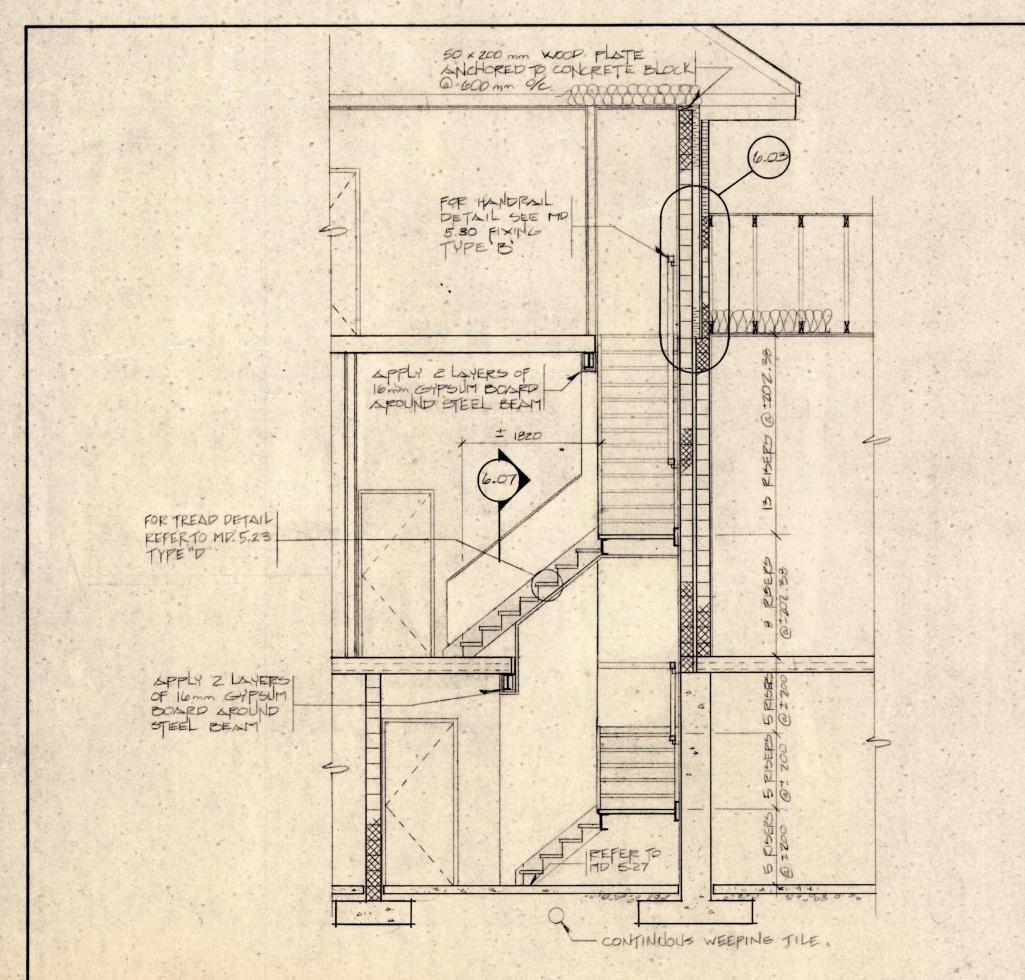


SCALE 1:50

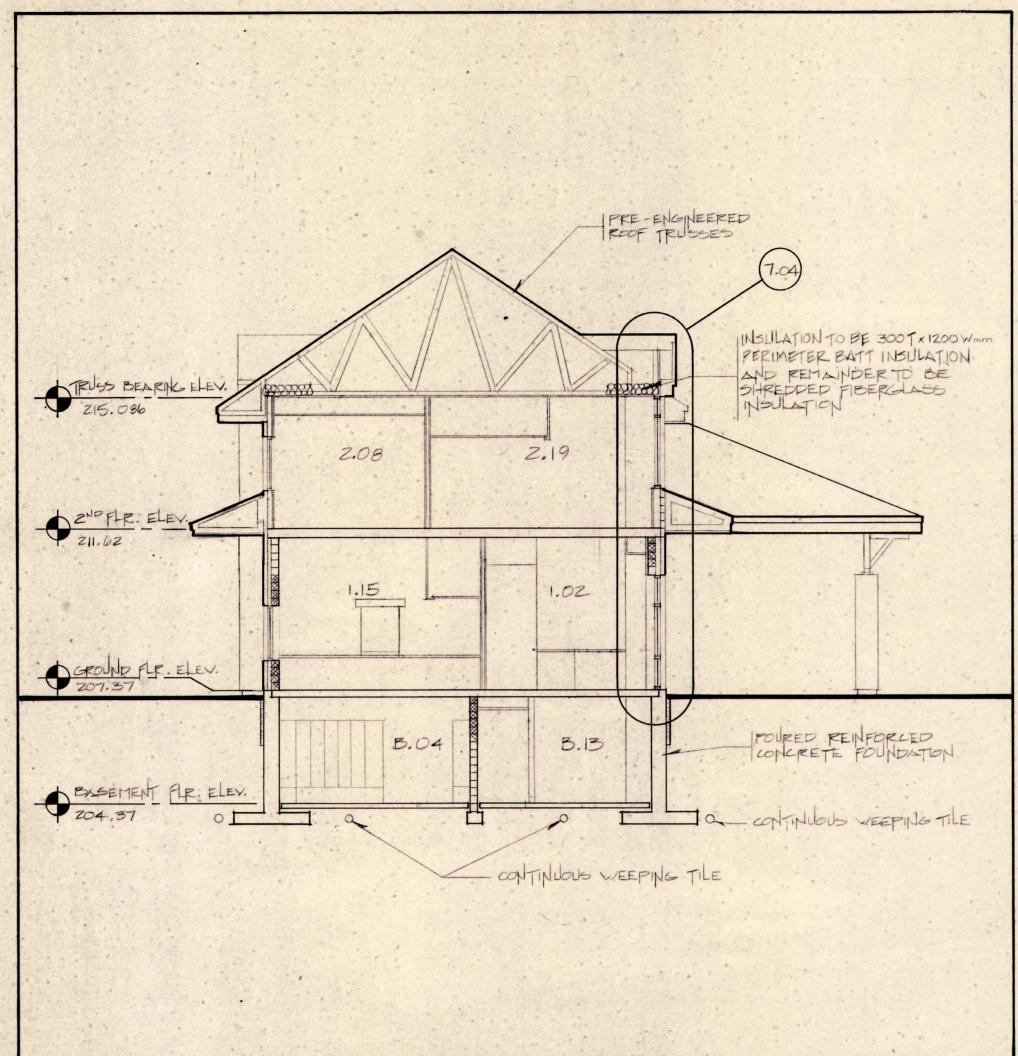


6.02 BUILDING SECTION SCALE 1:100

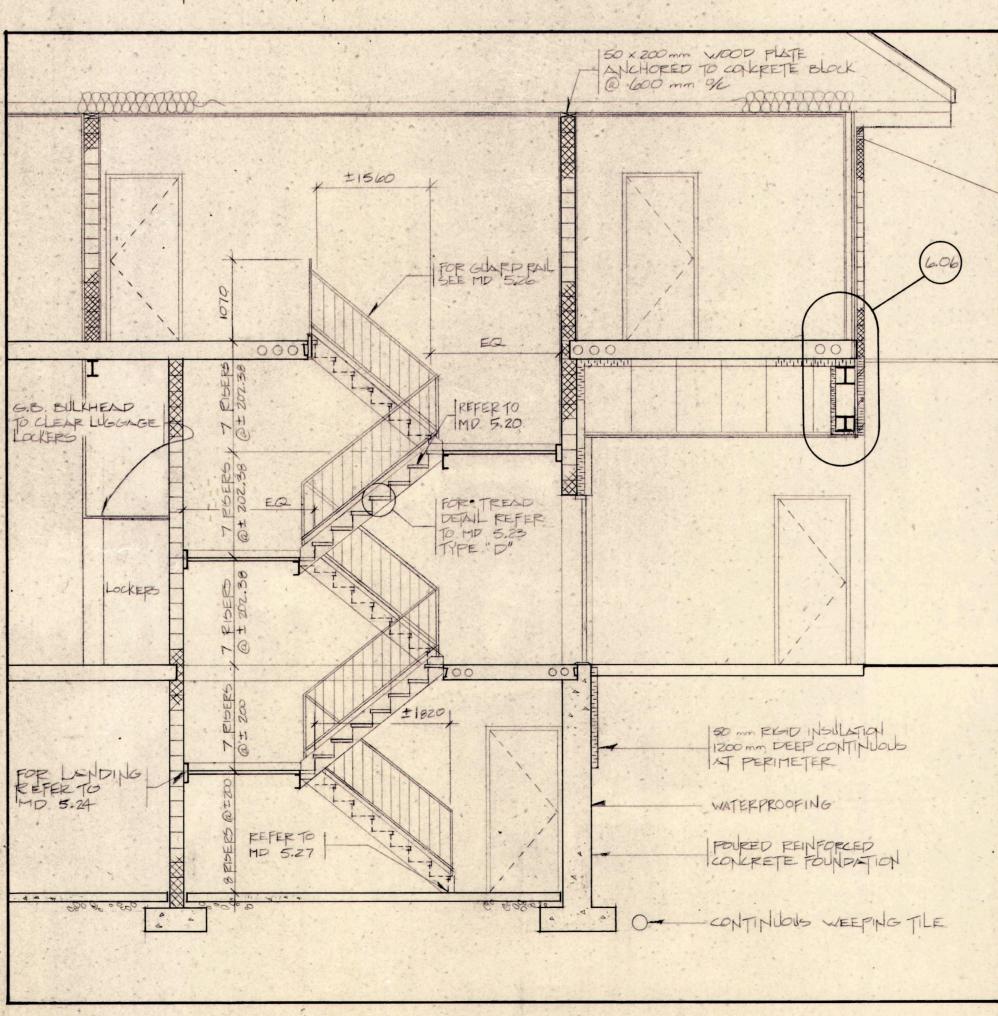


6.05 STAIR SECTION SULLE 1:50

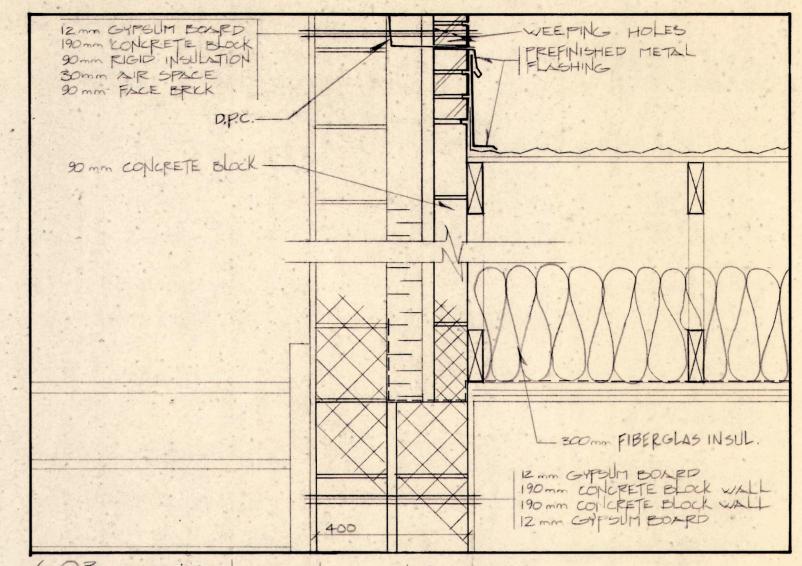


6.03 SECTION DETAIL SCALE 1:10

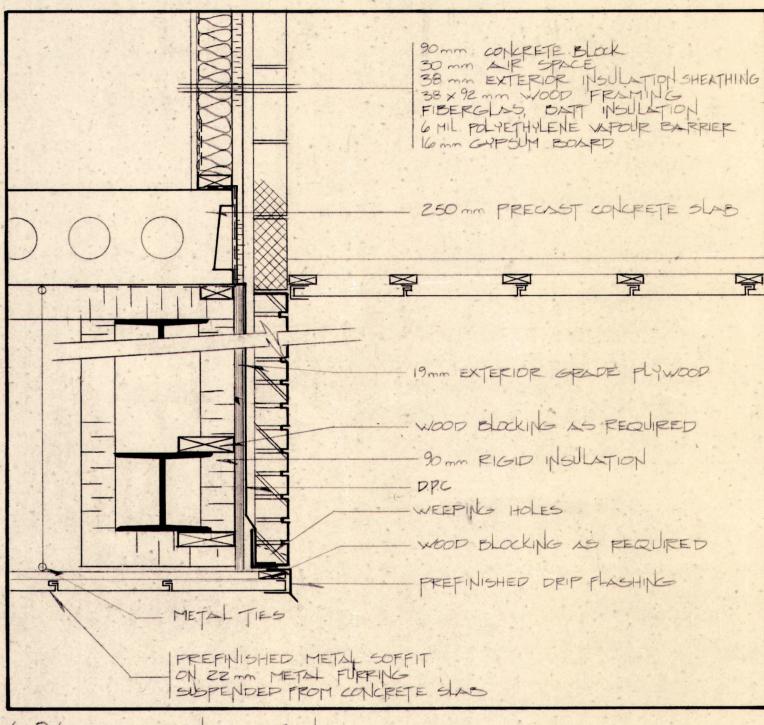

6.06 SECTION DETAIL SCALE 1:10

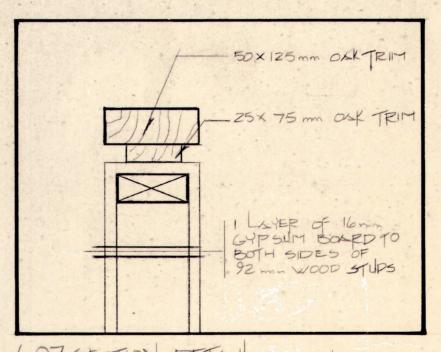

6.07 SECTION DETAIL SULE 1:5

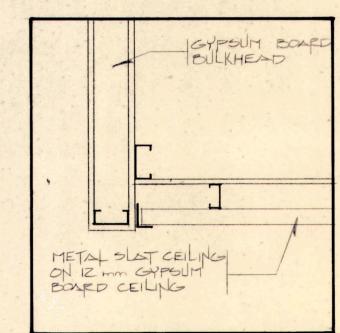

6.08 DETAIL SCALE 1:10

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Stewart Smith Architect Ltd., Timmins, Ont.


## DESCRIPTION OF DRAWING

BUILDING SECTION STAIR SECTIONS É DETAILS

SCALE AG NOTED

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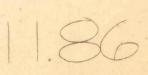
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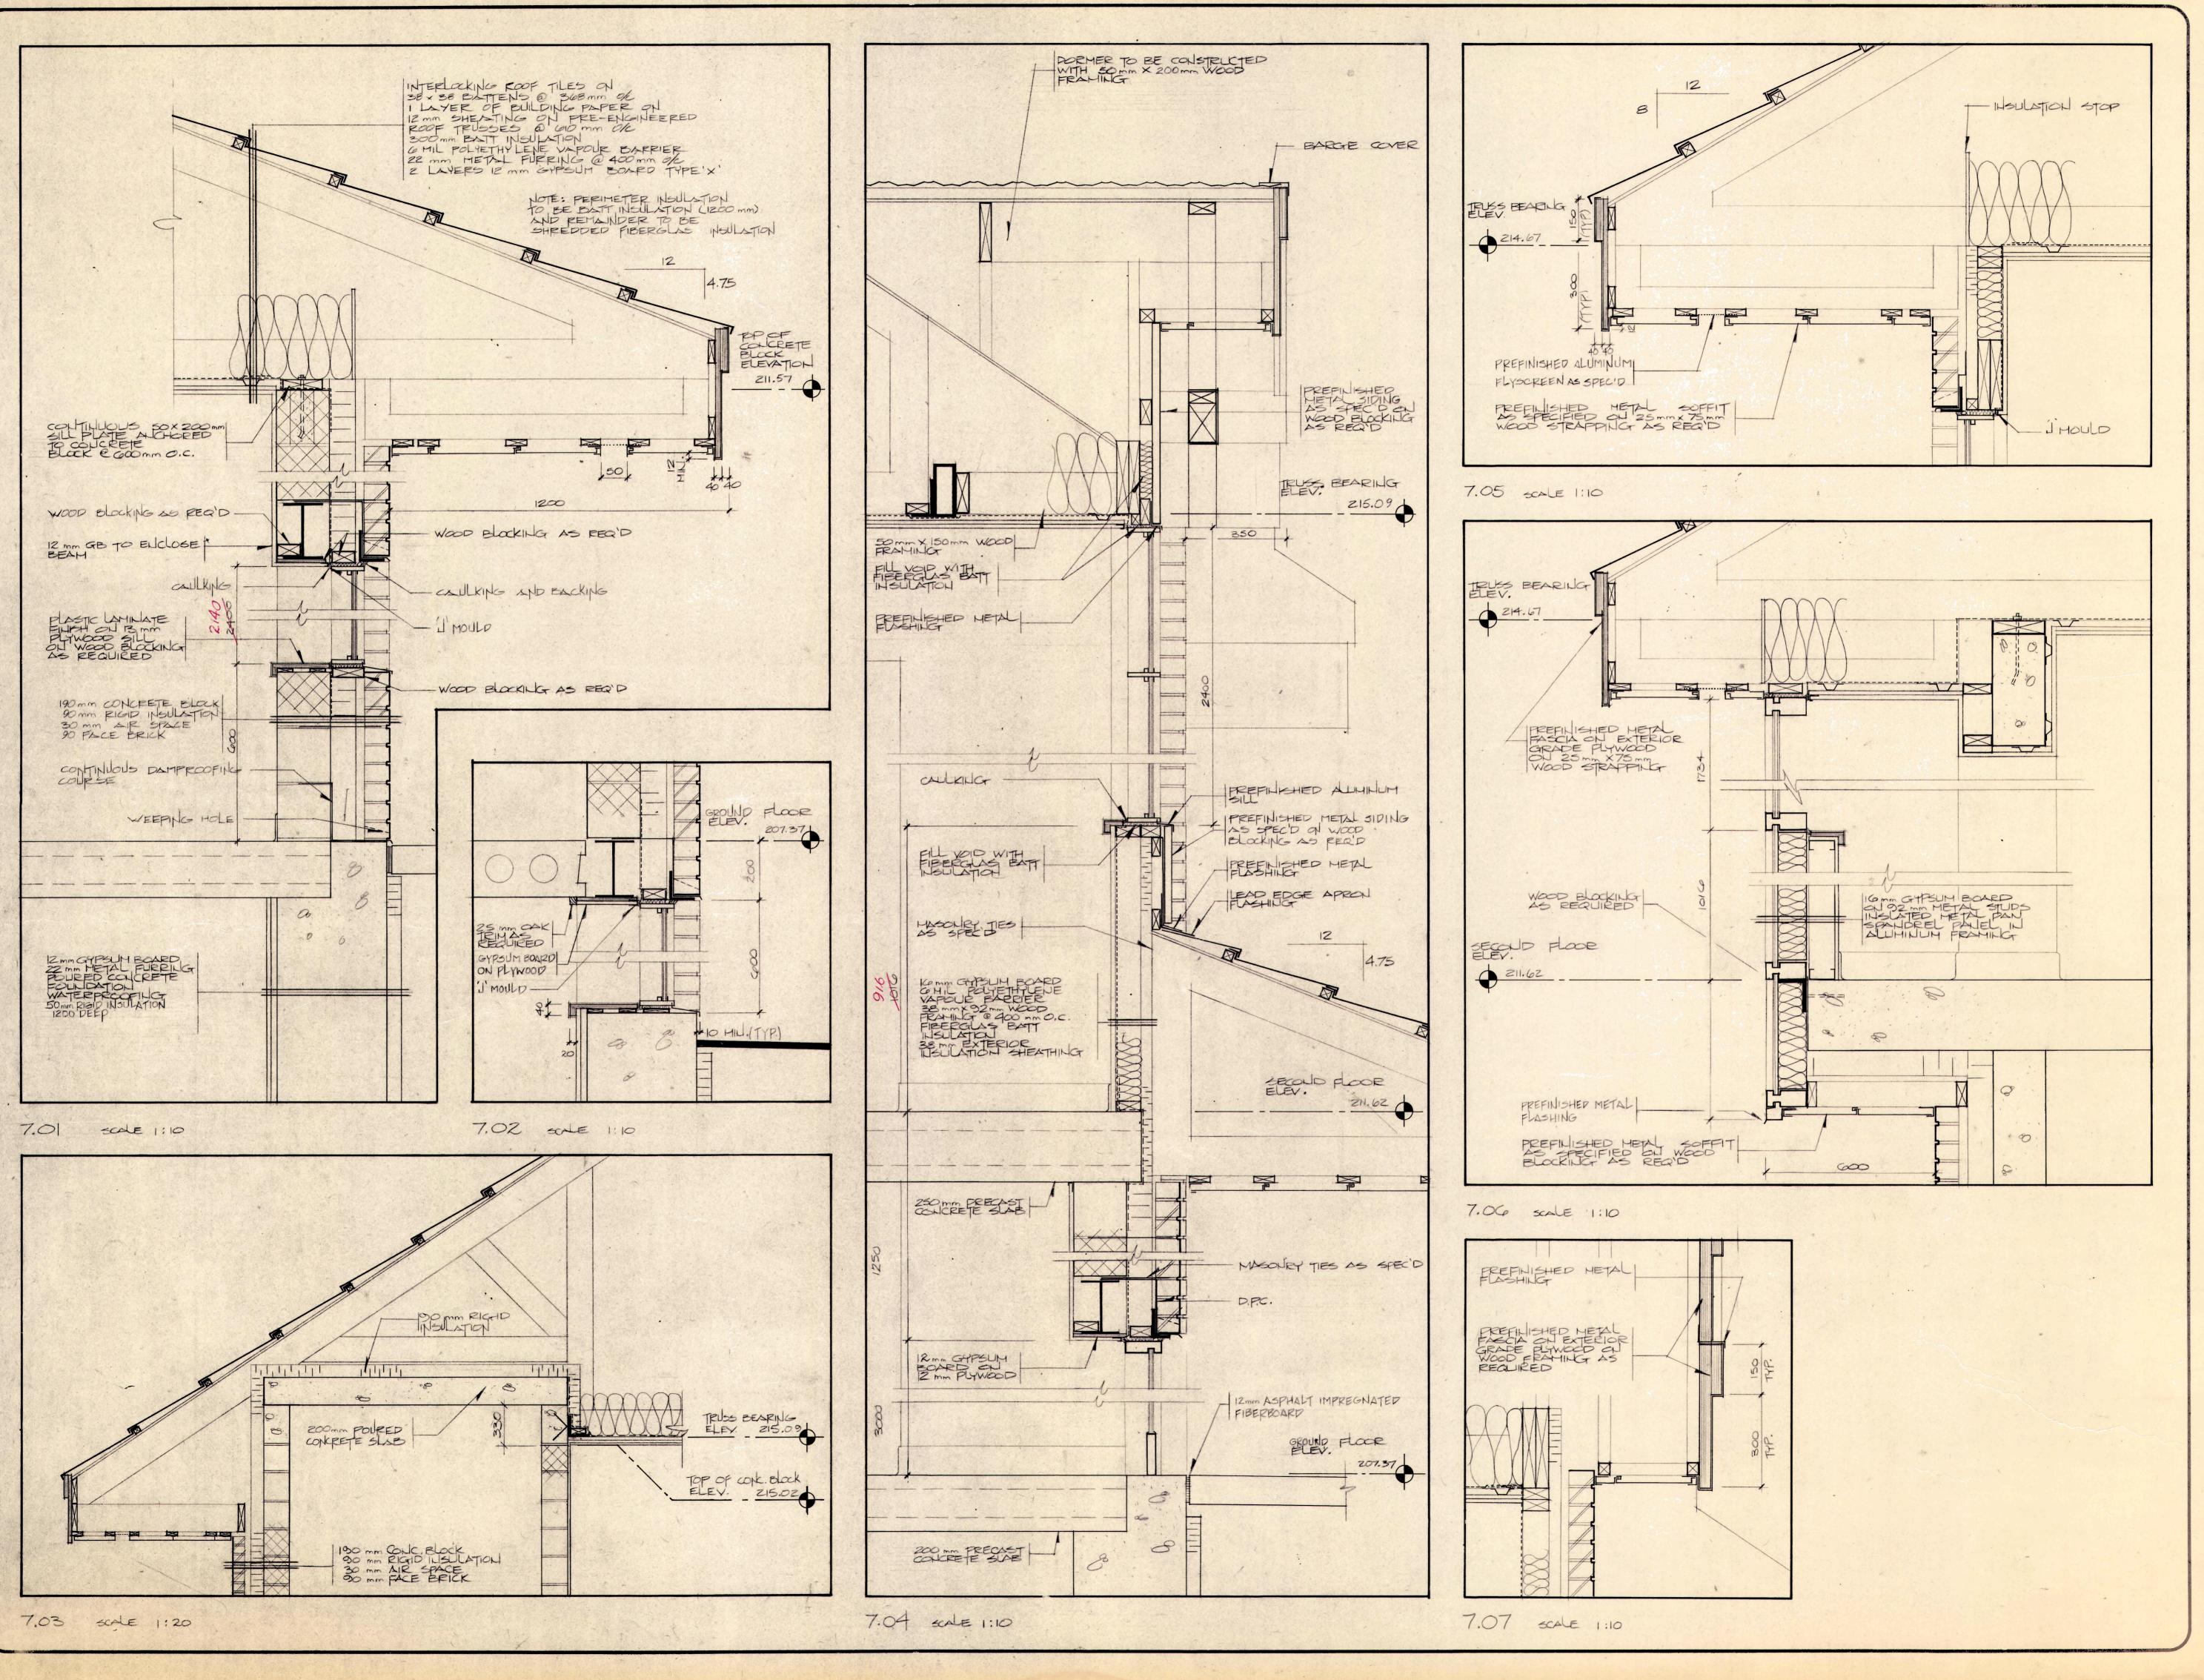


## PROJECT

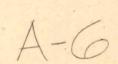INTERMODAL - INTERCITY BLIS & RAIL TERMINAL ELIGLEHART, ONTARIO

PROJECT NO.





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Smith Stewart Smith

Architect Ltd.,

Timmins, Ont.

DESCRIPTION OF DRAWING

SECTION DETAILS

SCALE AS NOTED

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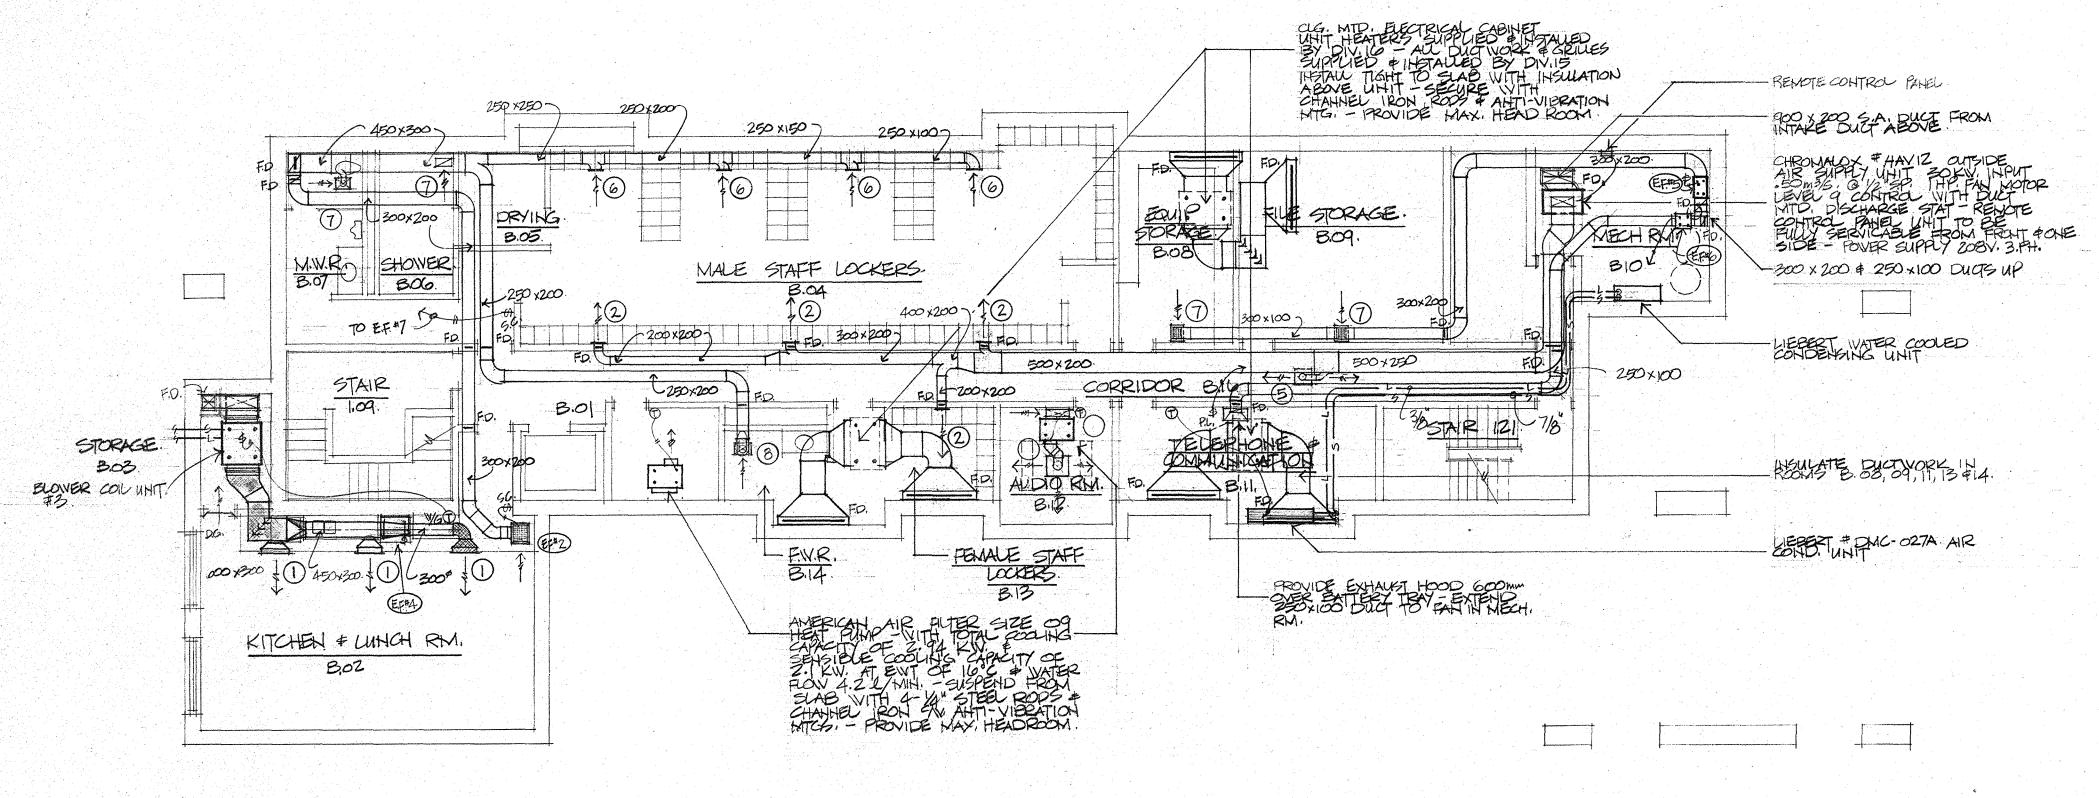
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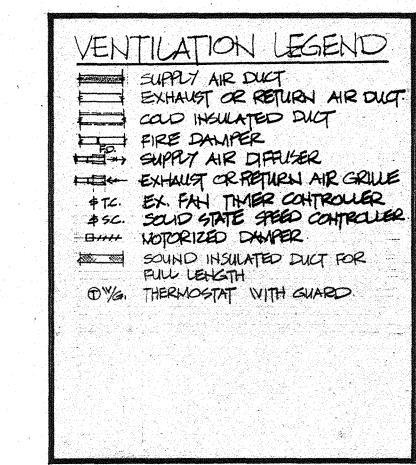
A-7

PROJECT


BLIS/RAIL TERMINAL ENGLEHART, ONTARIO

PROJECT NO.





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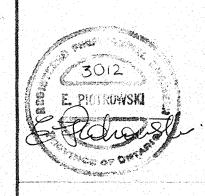
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ING WITH THE ORDER OF PRE-FABRICATED MATERIAL AND/

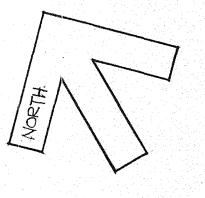OR CONSTRUCTION.

DATE PRINTED



## Smith Stewart Smi

Stewart Smith Architect Ltd., Timmins, Ont.

DESCRIPTION OF DRAWING

BASENEHT & GROUND FLOOR
VENTILATION & AIR
CONDITIONING PLANS

SCALE

1:100

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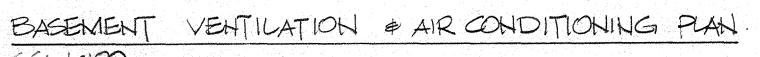
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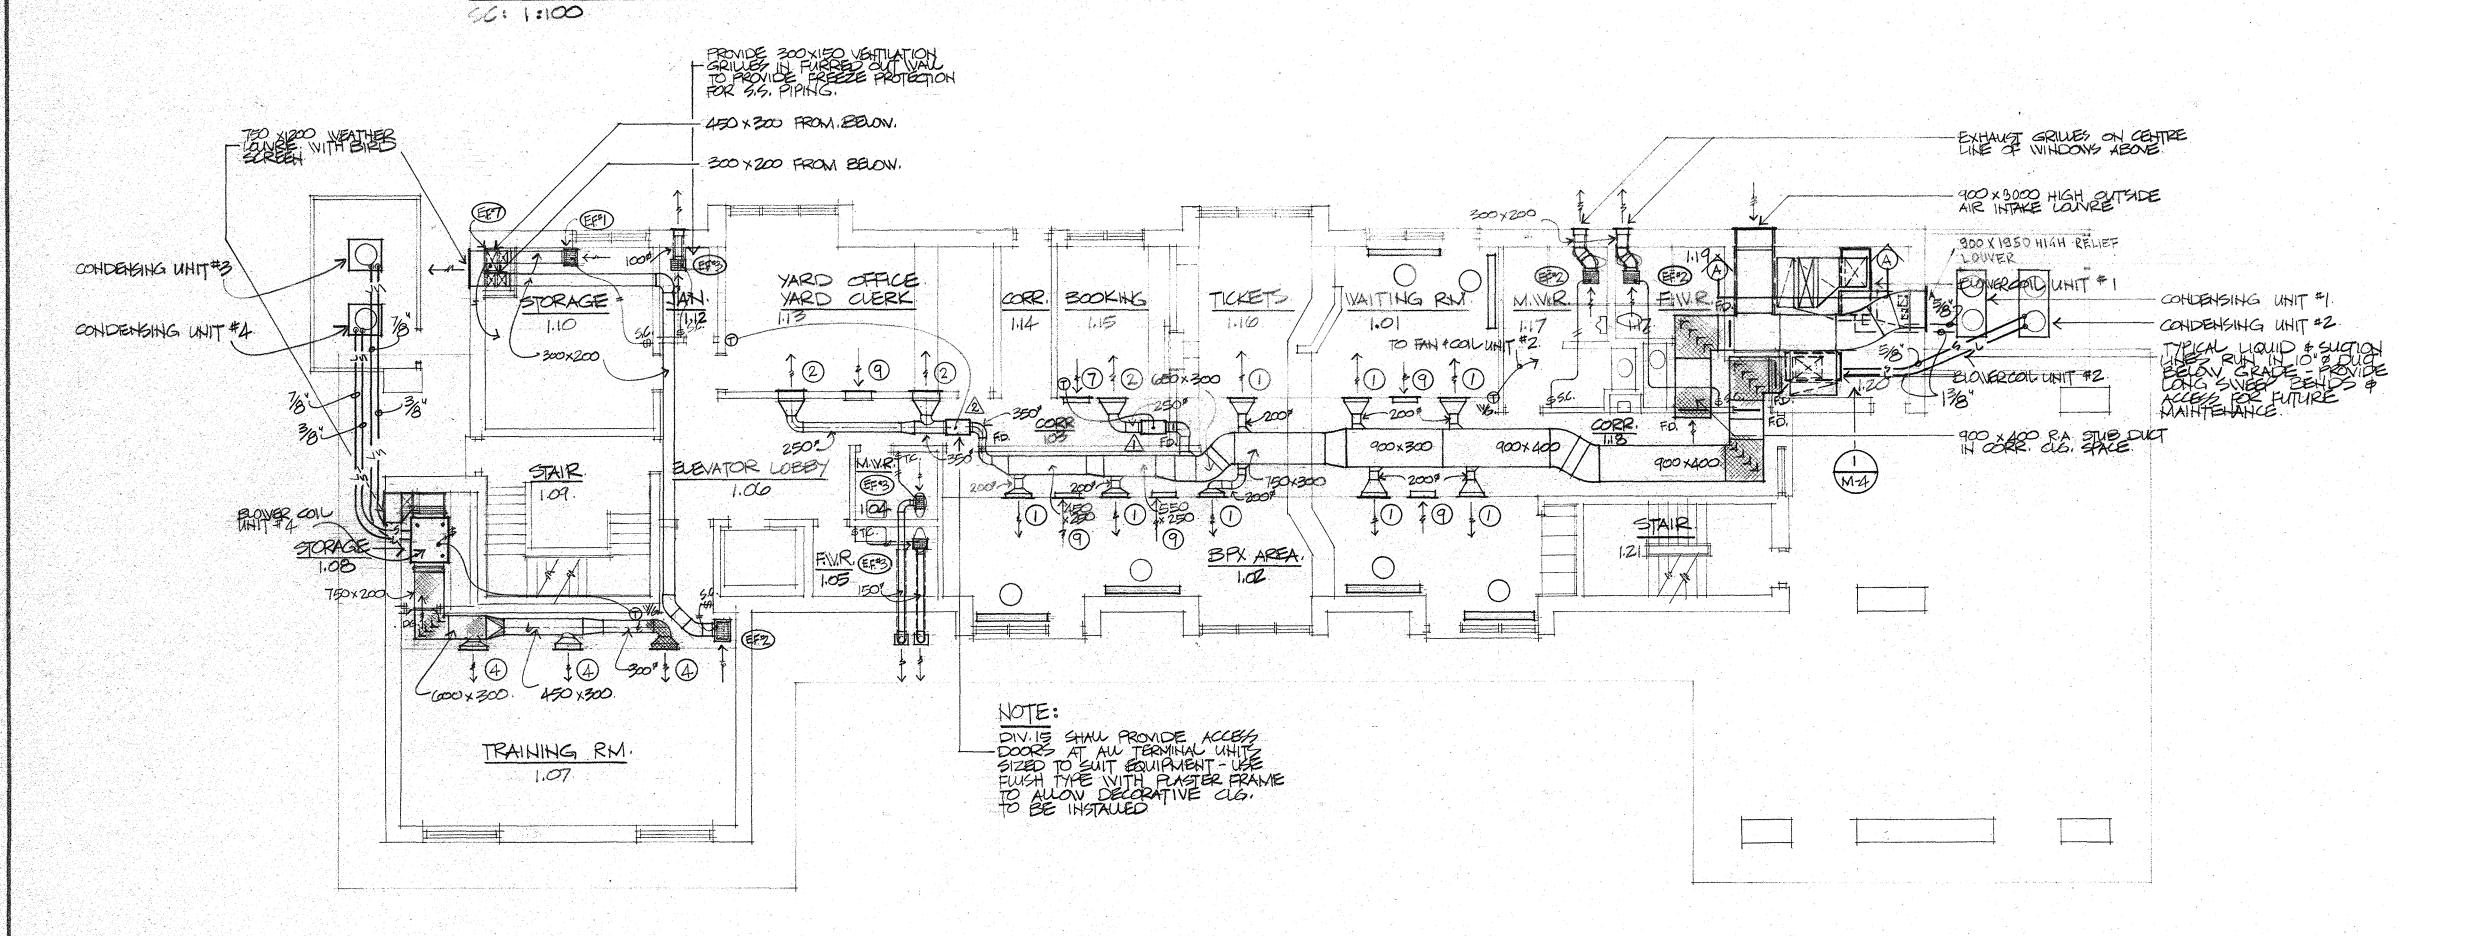
M-3

PROJECT


INTERMODAL - INTERCITY BUS & PAIL TERMINAL ENGLEHART, ONTARIO


PROJECT NO.






GROUND FLOOR VENTILATION & AIR CONDITIONING PLAN. 50: 1:100:

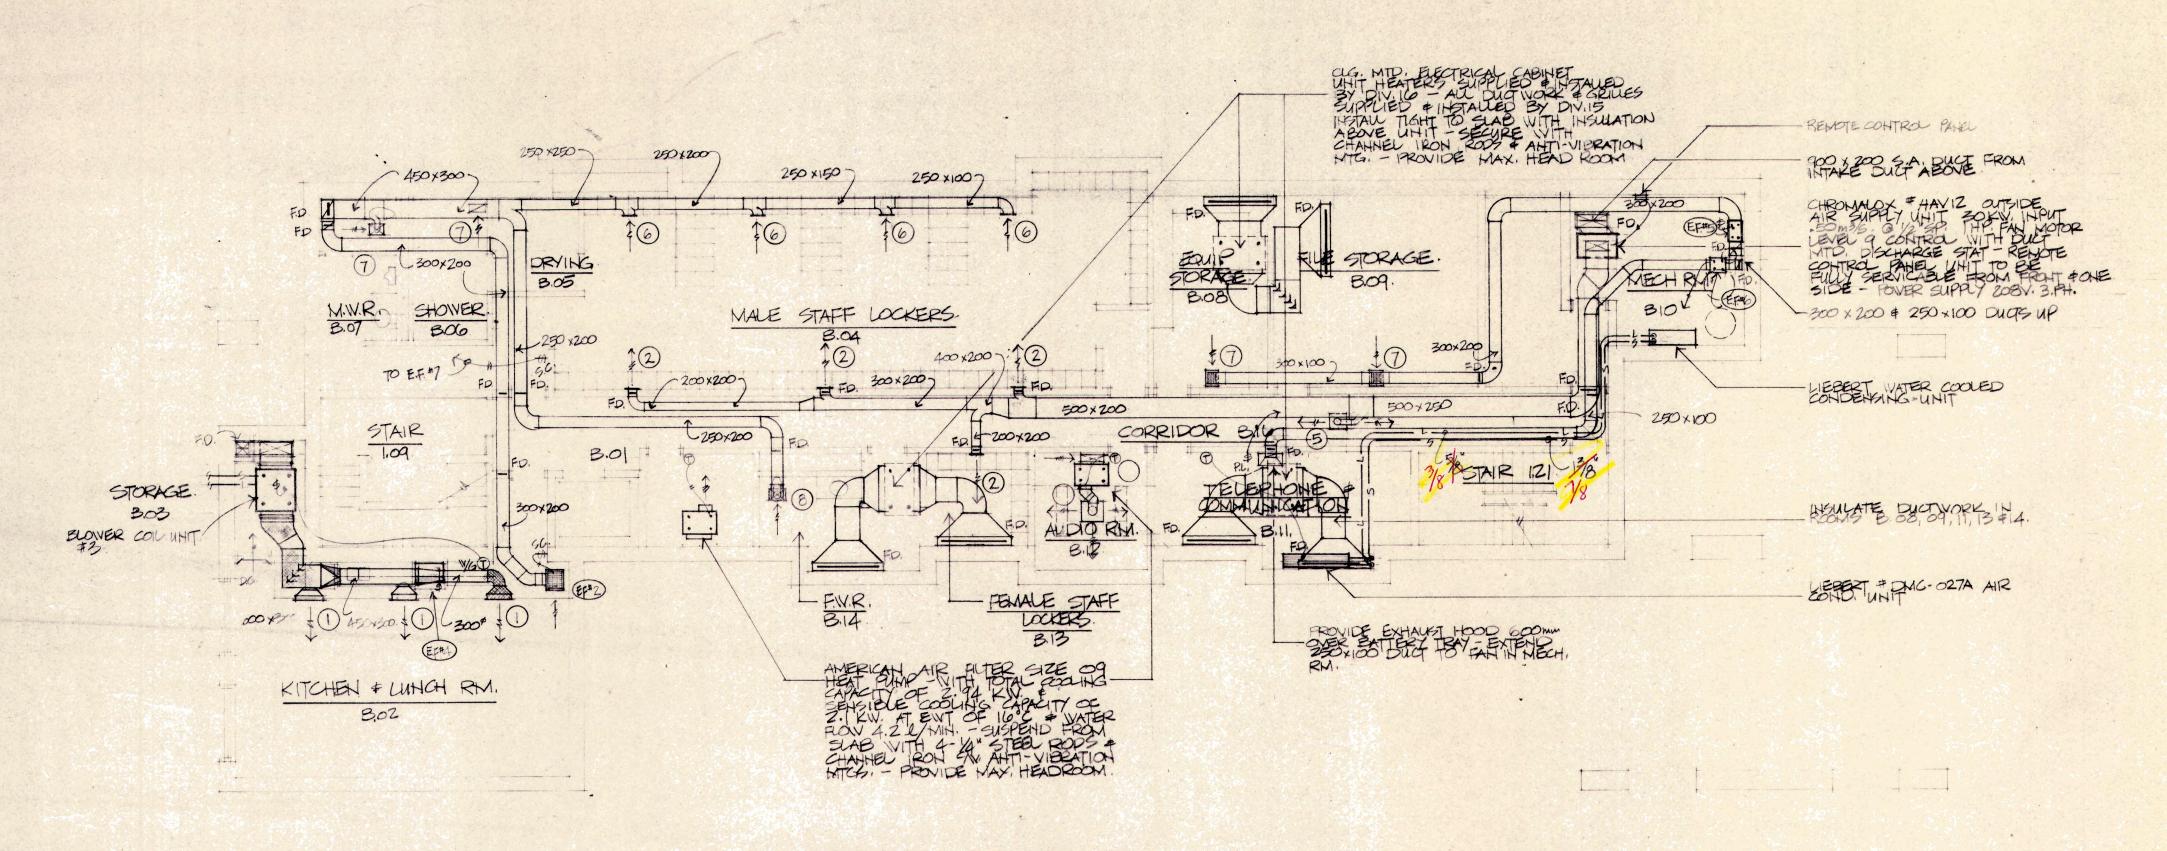

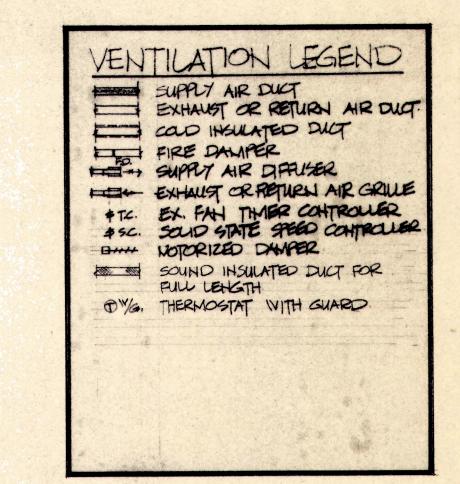


BASEMENT VENTILATION & AIR CONDITIONING PLAN

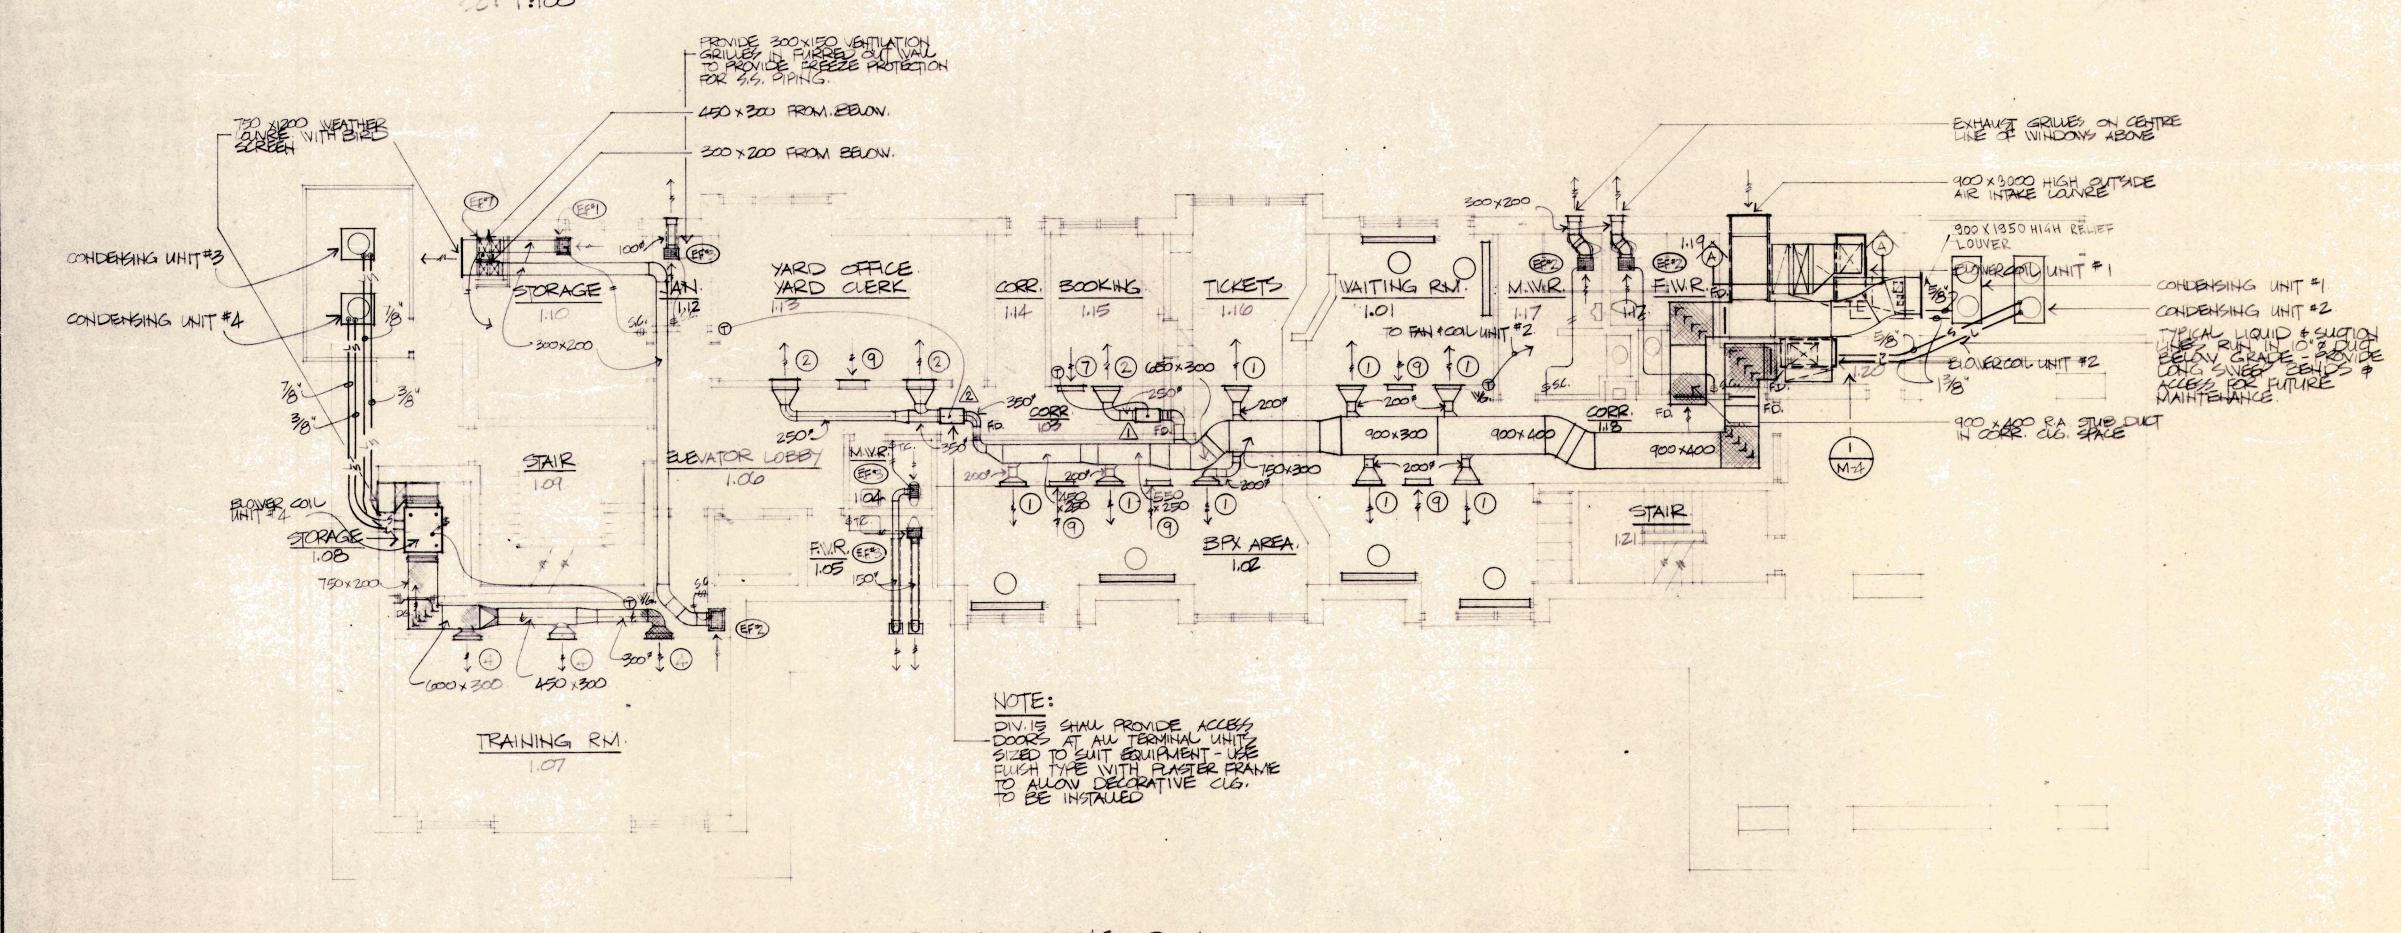

GROUND FLOOR VENTILATION & AIR CONDITIONING PLAN. SC: 1:100

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Smith

Stewart Smith Architect Ltd., Timmins, Ont.

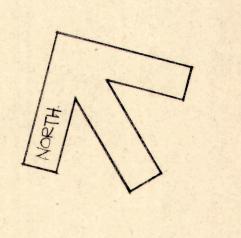DESCRIPTION OF DRAWING
BASEMENT & GROUND FLOOR
VENTILATION & AIR
CONDITIONING PLANS,

SCALE

1:100

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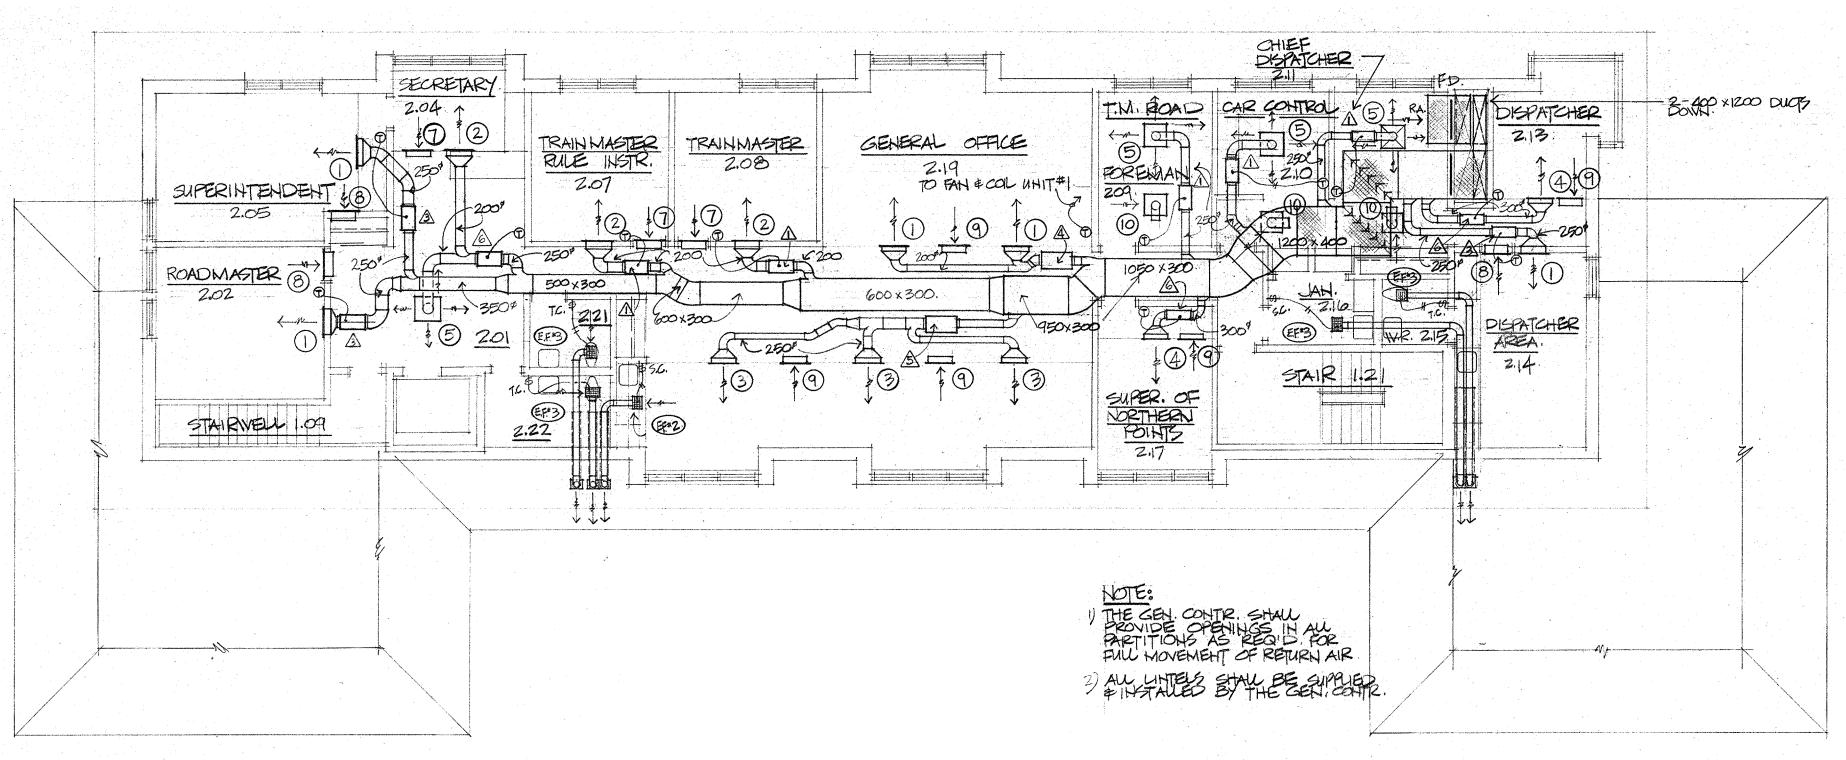
DRAWING NO.

M-3

PROJECT

INTERMODAL - INTERCITY BUS & PAIL TERMINAL ENGLEHART, ONTARIO

PROJECT NO.




SECOND FLOOR VENTILATION & AIR CONDITIONING PLAN.

SC: 1:50

 $\left(\begin{array}{c} I\\ M-4 \end{array}\right)$ 

INSTALLATION

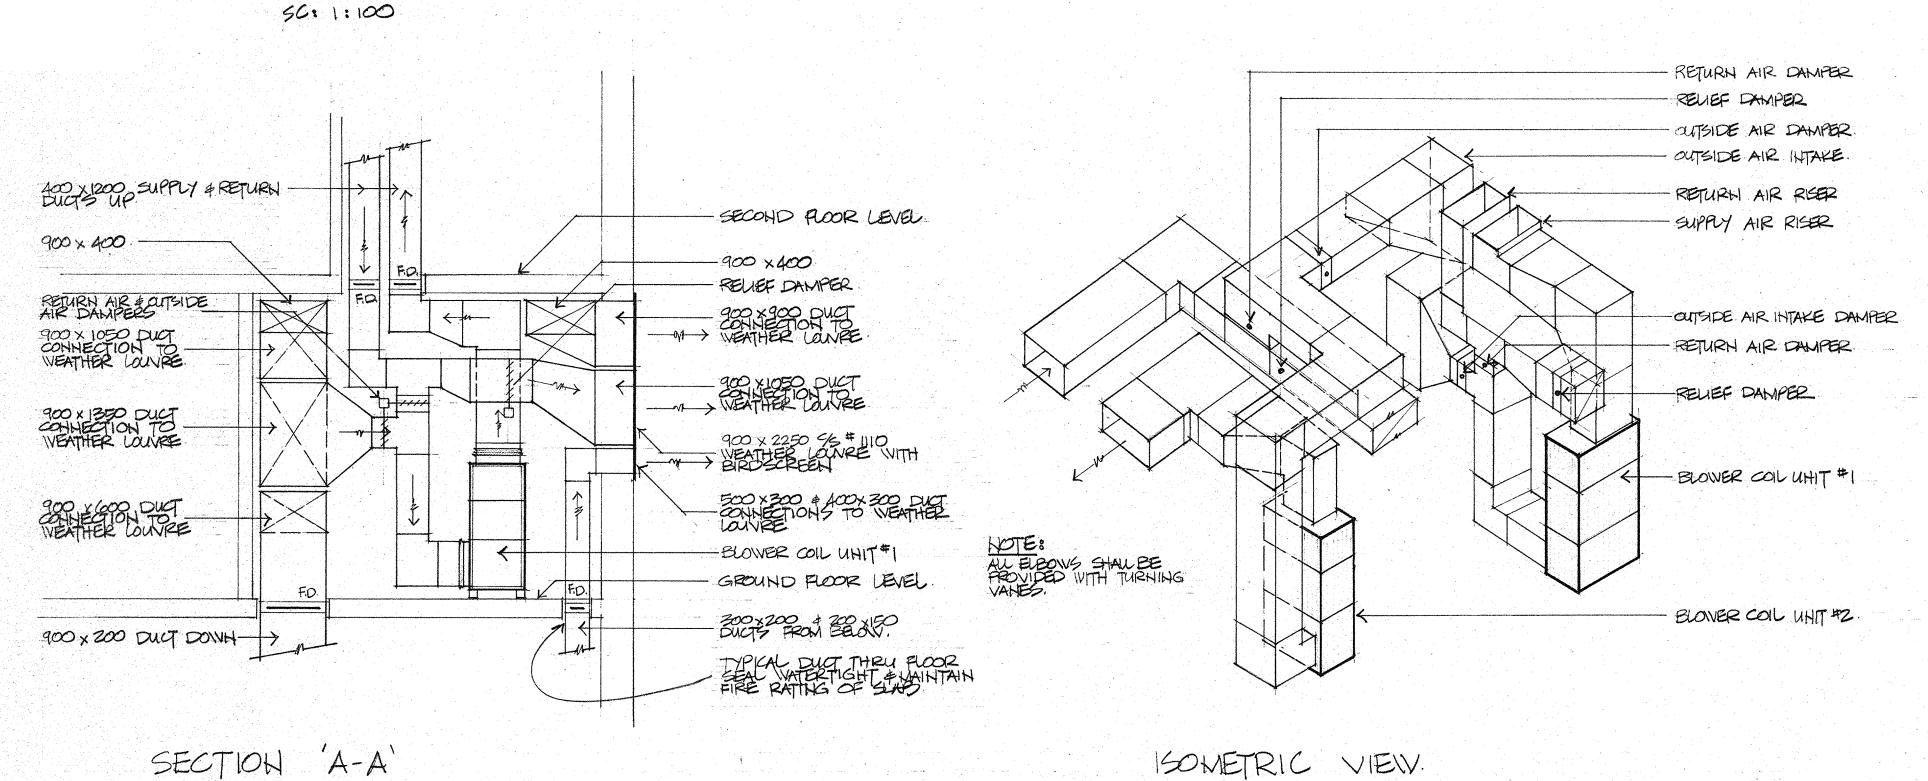

DETAILS @ MECH. ROOM 1.20

1) AN GRIVES I DIFFUSERS & REGISTERS SHAW HAVE A FACTORY APPLIED ANODIZED FINISH - COLOURS SHAW BE SELECTED BY THE ARCHITECT

2) ALL SOFFIT GRIVES SHALL BE HEAVY DUTY BIRD SCREENS IZED, ALUMINUM BORDER SW. FACTORY FINISH TO MATCH SOFFIT FINISH

<del></del>					
GRIL	LE, REG	ISTER	# DIFF	USER	SCHEDULE
NO: 1/5.	MODEL	USTEDSIZE	OVERALLSIZE	NEKYZE	HOTES.
140	5885 H.	500 x 200			
2 100	4	300 x200	-		
3 160	and a superior and a	600 x 200			
4 250	i i	800 x200			
<b>⑤</b> 1∞	) SH-A-4A,		600×600	300 x300/2004	TO FIT TAT' ag. GRID.
<b>6</b> 50	585 H.	200 x 150			
7 100		300×200			
8 150		500 × 200			
9 250	of Alberta and Williams	800 ×200			
(1)	SH-A-4A	And the second s	(000)×(000)	300 +300/2004	RA. FACE TO FIT 'TAT' CLG. GRID.

AU MODEL HUMBERS LISTED ARE BY KRUEGER - ALL SUPPLY AIR REGISTERS & DIFFUSERS SHALL BE STV. BALANCING DAMPERS.

The state of the s	EXH AUST FAL	1 6	CH	EC	) ULE	
HO.	TYPE	M3/5	K.W.	R.P.M.	5.P./Pa	NOTES.
(EFH)	PENN ZEPHYR Z-8	.10		1050	31.	MODEL 'RA'
EF#2)	PENH ZEPHYR Z-10	.19	13	1050	3	u u u u u u u u u u u u u u u u u u u
(EF+3)	NUTOHE # 8832C	.040				
EF4	NUTOHE * H-25 WE30 HOOD					91. LIGHT, FILTER MEDIA & CHARCOAL PA
EF95	PEHH ZEPHYR Z-10	.19		1050	3	MODEL'TDA'
EF46	PENH ZEPHYR Z-8	.10	•1	1050	31	MODEL TOA'
EF*7	PENH ZEPHYR Z-14	•55	.37	1100	125	MODEL TO

HOTE:
PROVIDE BACKDRAFT DAMPERS AT ALL DISCHARGE POINTS.
(GRAVITY TYPE)

HO.	MODEL	ARBOW	ESP	翻	多	COOLING	瑪幽	MINIST	POWER SUPPLY
	CB17-135V.	2125	125	740	1500	37.7	20.8/2	88.4	208 V. 3PH.
2	CB17-95V.	1416	125	650	1125	27.8	11.5/1	46.8	208V 39H
3	CBS 18-51	708	75	MEDIAM	315	17.1	6.0/2	40.5	2084. SiAH.
4	CBF16-31-00	420	75	MEQUM	750	8.8	3.8/1	25	2084 S.M.

NOTE: NODEL HUMBERS GIVEN ARE LEMOX

	CON	DENSING	WIT SO	CHEDUL	E
L	40.	MODEL	cooling kiv.	MIH. CO. AMPS.	POWER SUPPLY
		HS17-1353	37.2	44.9	208 V. 394.
	-	HS17 - 953	27.8	28.7	208V, 39H,
T		HS14-653V	(* 1 <b>7.</b> 12. 12.	23.2	208V. 3PH.
	4	H516-31V	8.8	20.9	208V. S.A.

HOTE: MODEL HUMBERS GIVEN ARE LENHOX.

TER	MIHAL	UH	1.	90	HEDUL.	
WARKED .	MODEL	45	SP.	H.C.	AIR OUTLET ARRANGEMENT	AIR OUTLET SIZE
Δ	300	100	.03	21	В	225*
◬	500	200	.04	22	В	225 <sup>8</sup>
A	500	140	.04	22	В	225*
A	1000	320	0.5	27	H	2-175
A	1500	480	0.9	31		3-250
<u> </u>	750	250	205	27	В	1-3008

NOTE: MODEL HUMBERS GIVEN ARE TEMPMAGTER TYPE, MSR! - PROVIDE AIR BAVANCING DAMPER UP STREAM OF EACH UNIT THIS DRAWING AS AN INSTRU-MENT OF SERVICE IS THE PRO-PERTY OF THE ARCHITECT, AND MAY NOT BE REPRODUCED WITHOUTHIS PERMISSION AND UNLESS THE REPRODUCTION CARRIES HIS NAME AS ARCHI-TECT.

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AG-BLILLES

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Smith Stewart Smith Architect Ltd.,

Timmins, Ont.

DESCRIPTION OF DRAWING SECOND FLOOR VEHTILATION # AIR CONDITIONING FLAN # DETAILS

SCALE 46 NOTED

DRAWN BY CJ.S.

DRAWING NO.

M-4

PROJECT

INTERMODAL -INTERCITY BUS & PAIL TERMINAL ENGLEHART, ONTARIO

PROJECT NO.